JEA Water & Wastewater Standards Manual

VOLUME 5A: Water Treatment Plant Details

January 1, 2026 – Edition

JEA Water and Wastewater Standards

Volume 5A – Water Treatment Plant Details 2025 SUMMARY OF MAJOR CHANGES

Exhibit 3-1

- Remove concrete pipe supports and add stainless steel pipe supports.
- Relocate flow meter to more accurately represent location.
- Remove acidization ports.

Exhibit 6-1A

Change free chlorine test station to show correct analyzer.

Exhibit 6-3

- Remove schematic diagram of sodium hypo skid.
- Added note directing to Exhibit 6-5 for hypo skid details.

Exhibit 6-5

- Remove pressure relief valve from metering pump discharge piping.
- Remove dampener from metering pump discharge piping.


JEA Water and Wastewater Standards


Volume 5A - Water Treatment Plant Standards


Table of Contents:


WATER TREATMENT PLANT DETAILS


WATER TREATMENT PLANT WTP PROCESS FLOW DIAGRAM &		
HYDRAULIC PROFILE COMPONENTS	EXHIBIT I-1	3
TYPICAL WTP HYDRAULIC PROFILE	EXHIBIT I-2	4
TYPICAL WTP SITE LAYOUT AND MAJOR YARD PIPING	EXHIBIT II-3	5
TYPICAL SUPPLY WELL PLAN, SECTION, AND DETAILS	EXHIBIT III-1	6
GROUND STORAGE TANK GENERAL LAYOUT	EXHIBIT IV-1	7
GROUND STORAGE TANK GENERAL SECTION &		
OVERFLOW & DRAIN TANK DETAIL	EXHIBIT IV-2	8
GROUND STORAGE TANK GENERAL TRAY AERATOR DETAIL		
SODIUM HYPOCHLORITE INJECTION AND SAMPLE STATION DETAILS	EXHIBIT VI-1	10
SODIUM HYPOCHLORITE INJECTION AND SAMPLE STATION DETAILS	EXHIBIT VI-1A	11
SODIUM HYPOCHLORITE SYSTEM SCHEMATIC	EXHIBIT VI-3	12
GENERAL LAYOUT OF SODIUM HYPOCHLORITE STORAGE AND		
METERING FACILITY		
TYPICAL SODIUM HYPOCHLORITE METERING PUMP SKID ASSEMBLY	EXHIBIT VI-5	14
AUTOMATIC TRANSFER SWITCH SCHEMATIC	EXHIBIT VII-2	15
SOFT START TYPICAL SCHEMATIC	EXHIBIT VII-3	16
SODIUM HYPOCHLORITE SYSTEM TYPICAL SCHEMATIC		
HSPS STARTER VFD TYPICAL SCHEMATIC		
SCADA PANEL ELEVATION TYPICAL	EXHIBIT VIII-4	19
SCADA PANEL INTERNAL ELEVATION TYPICAL		
SCADA PANEL POWER TYPICAL SCHEMATIC		
RTU TYPICAL		
FIBER CONNECTED PROFIBUS WELL PANEL TYPICAL		
RADIO CONNECTED PROFIBUS WELL PANEL TYPICAL		
CHEMICAL AND HIGH SERVICE PUMP STATION BUILDING TYPICAL LAYOUT		
WTP SITE CONCEPTUAL LANDSCAPING PLAN		
WELL SITE CONCEPTUAL LANDSCAPING PLAN	EXHIBIT XV-3	27

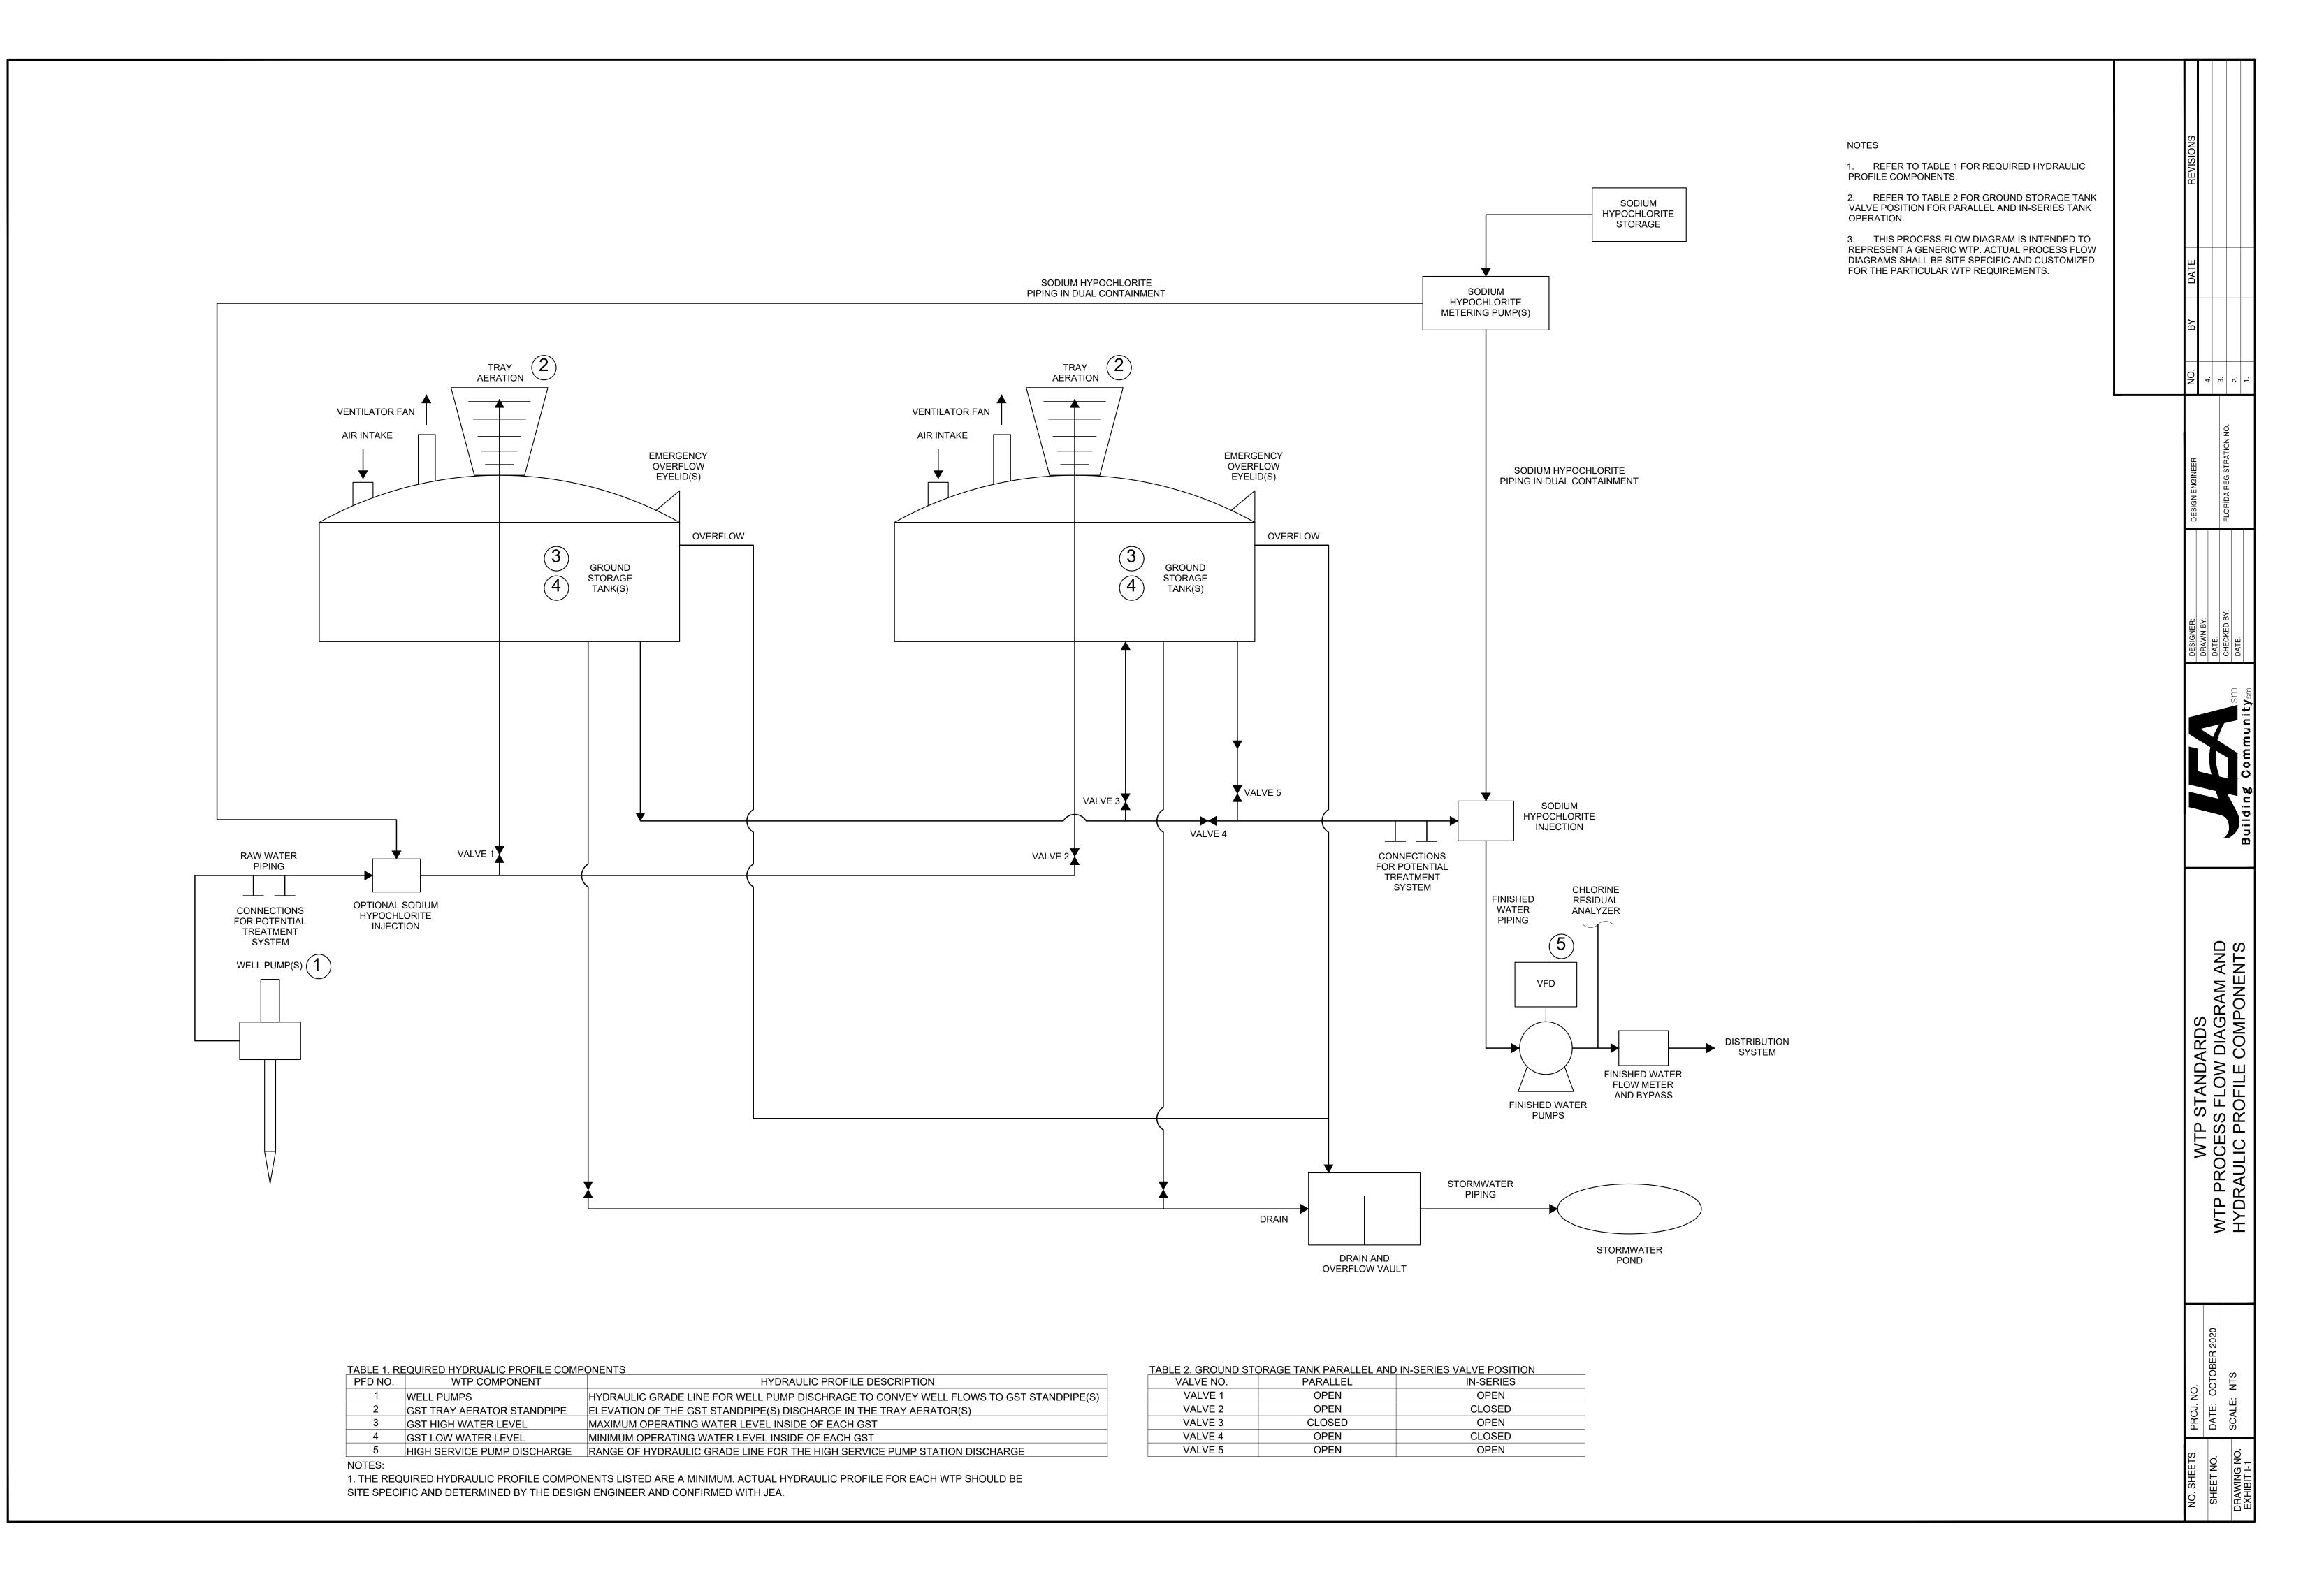


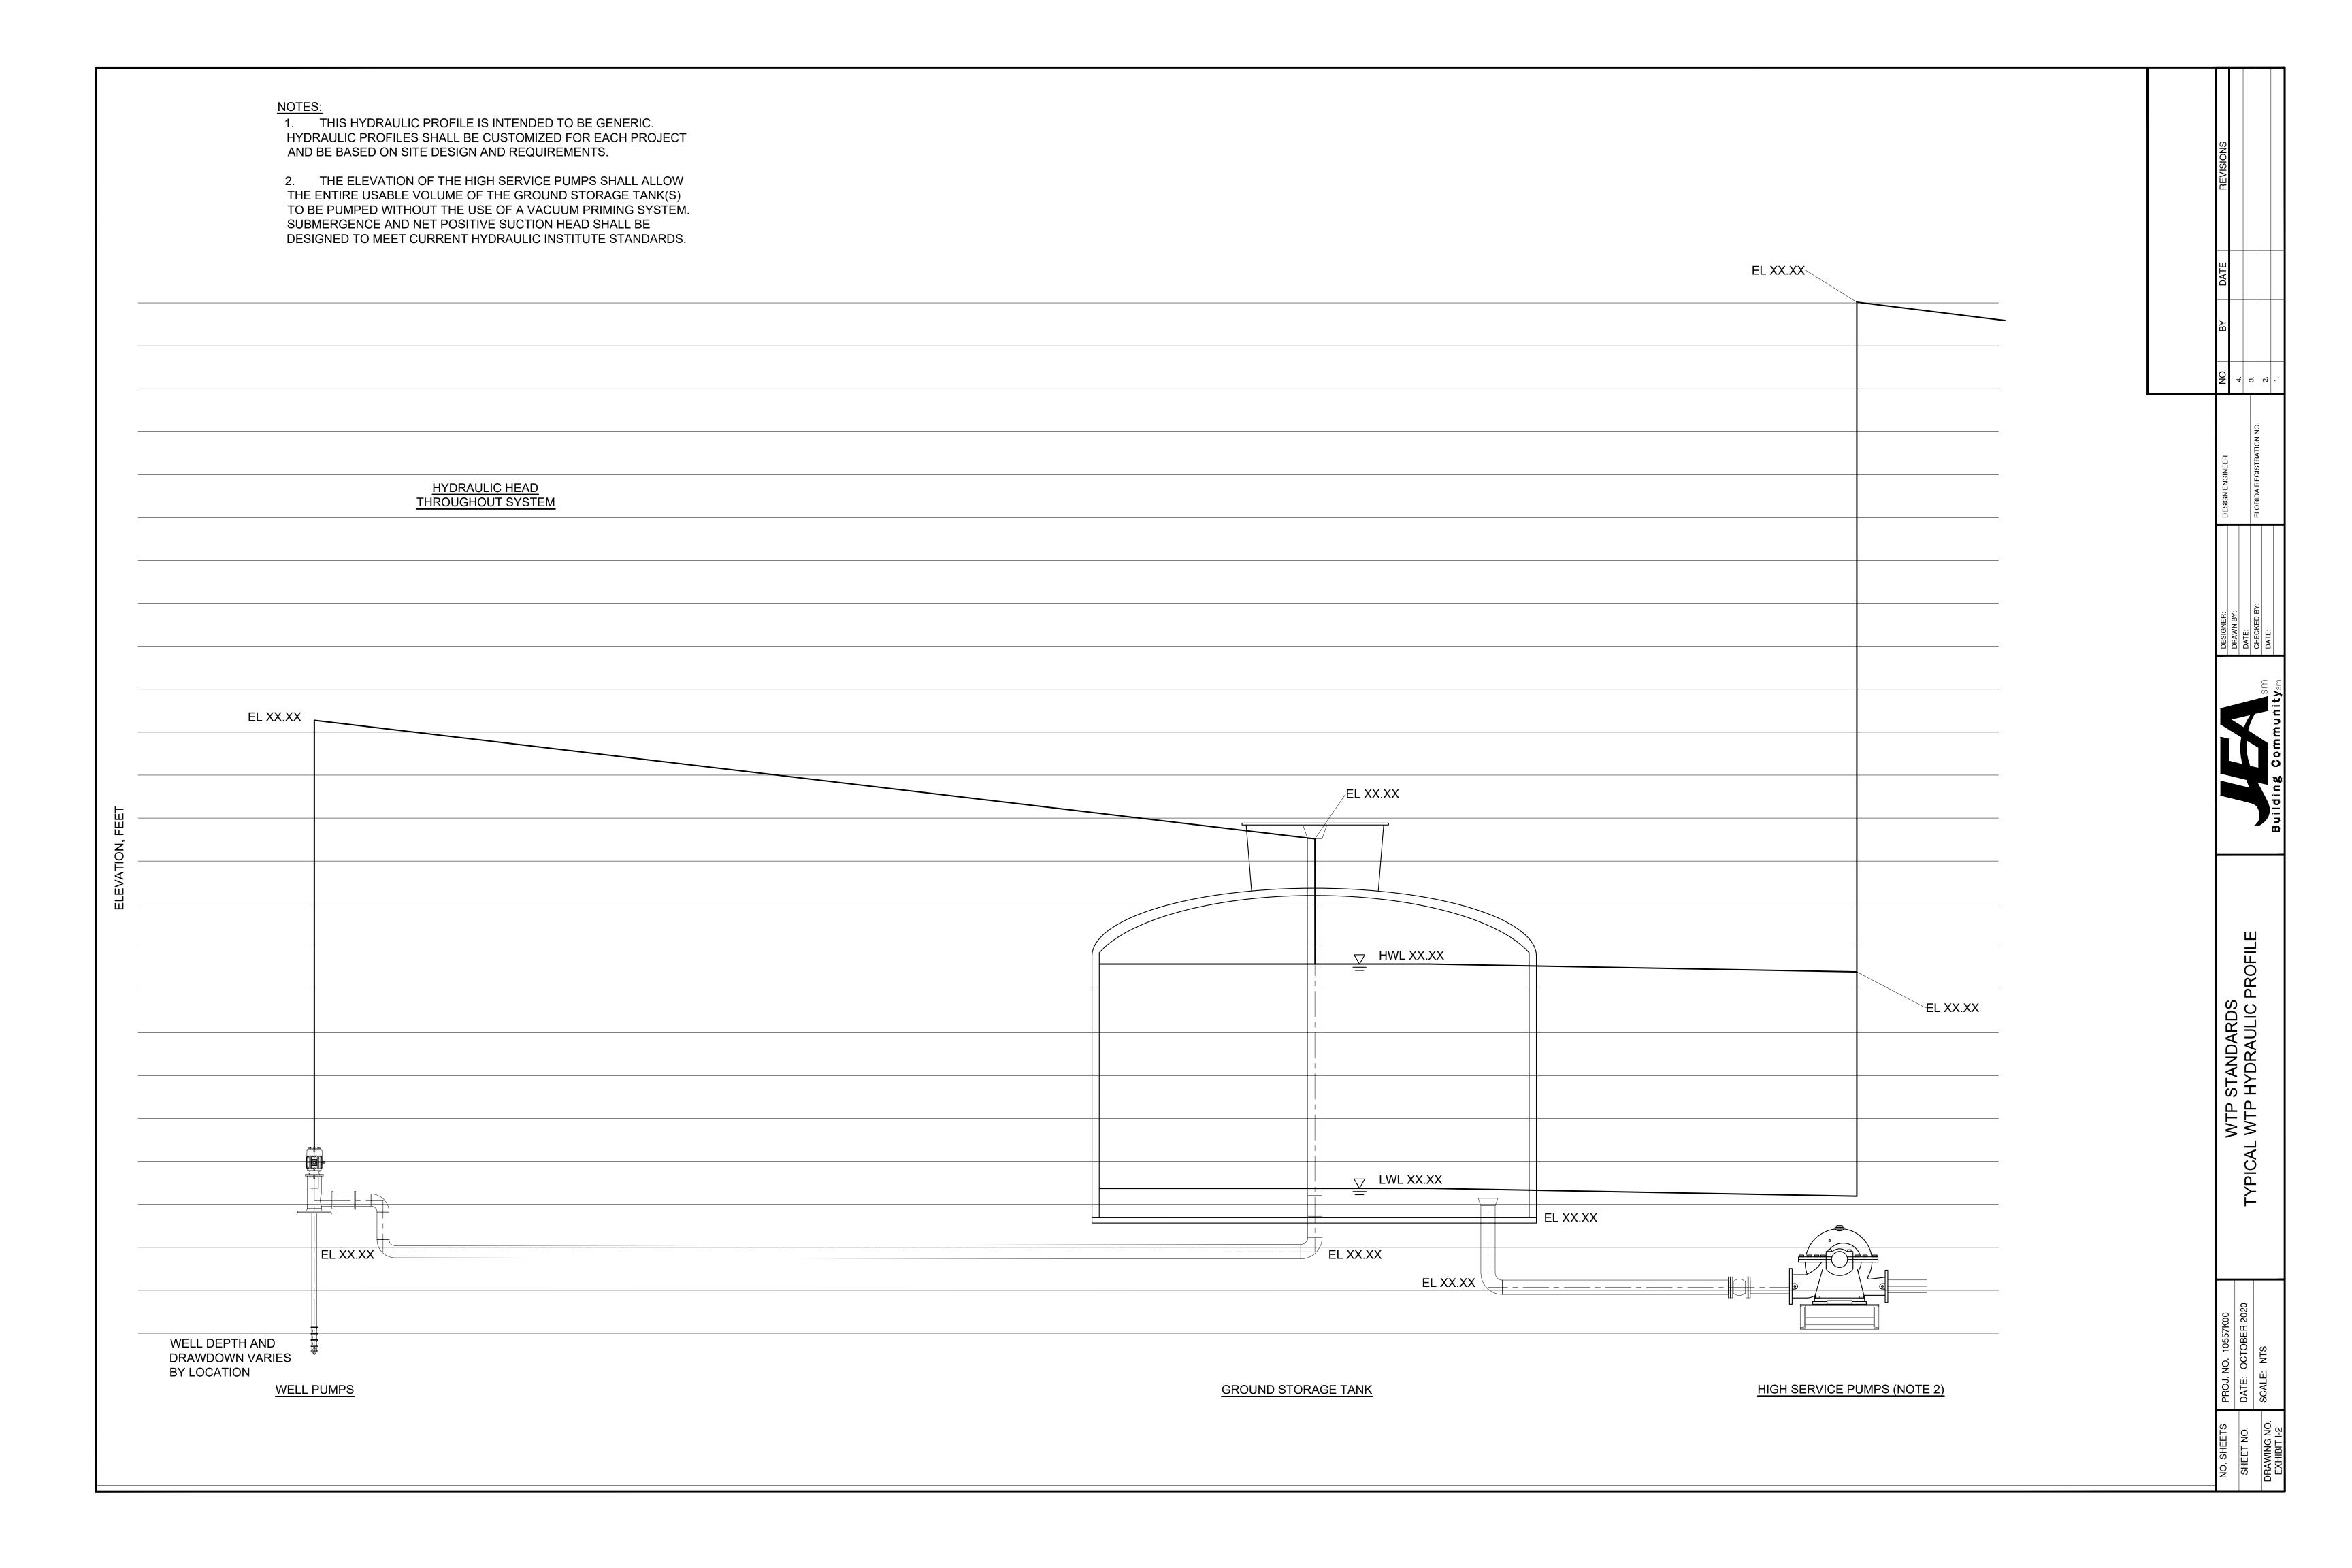


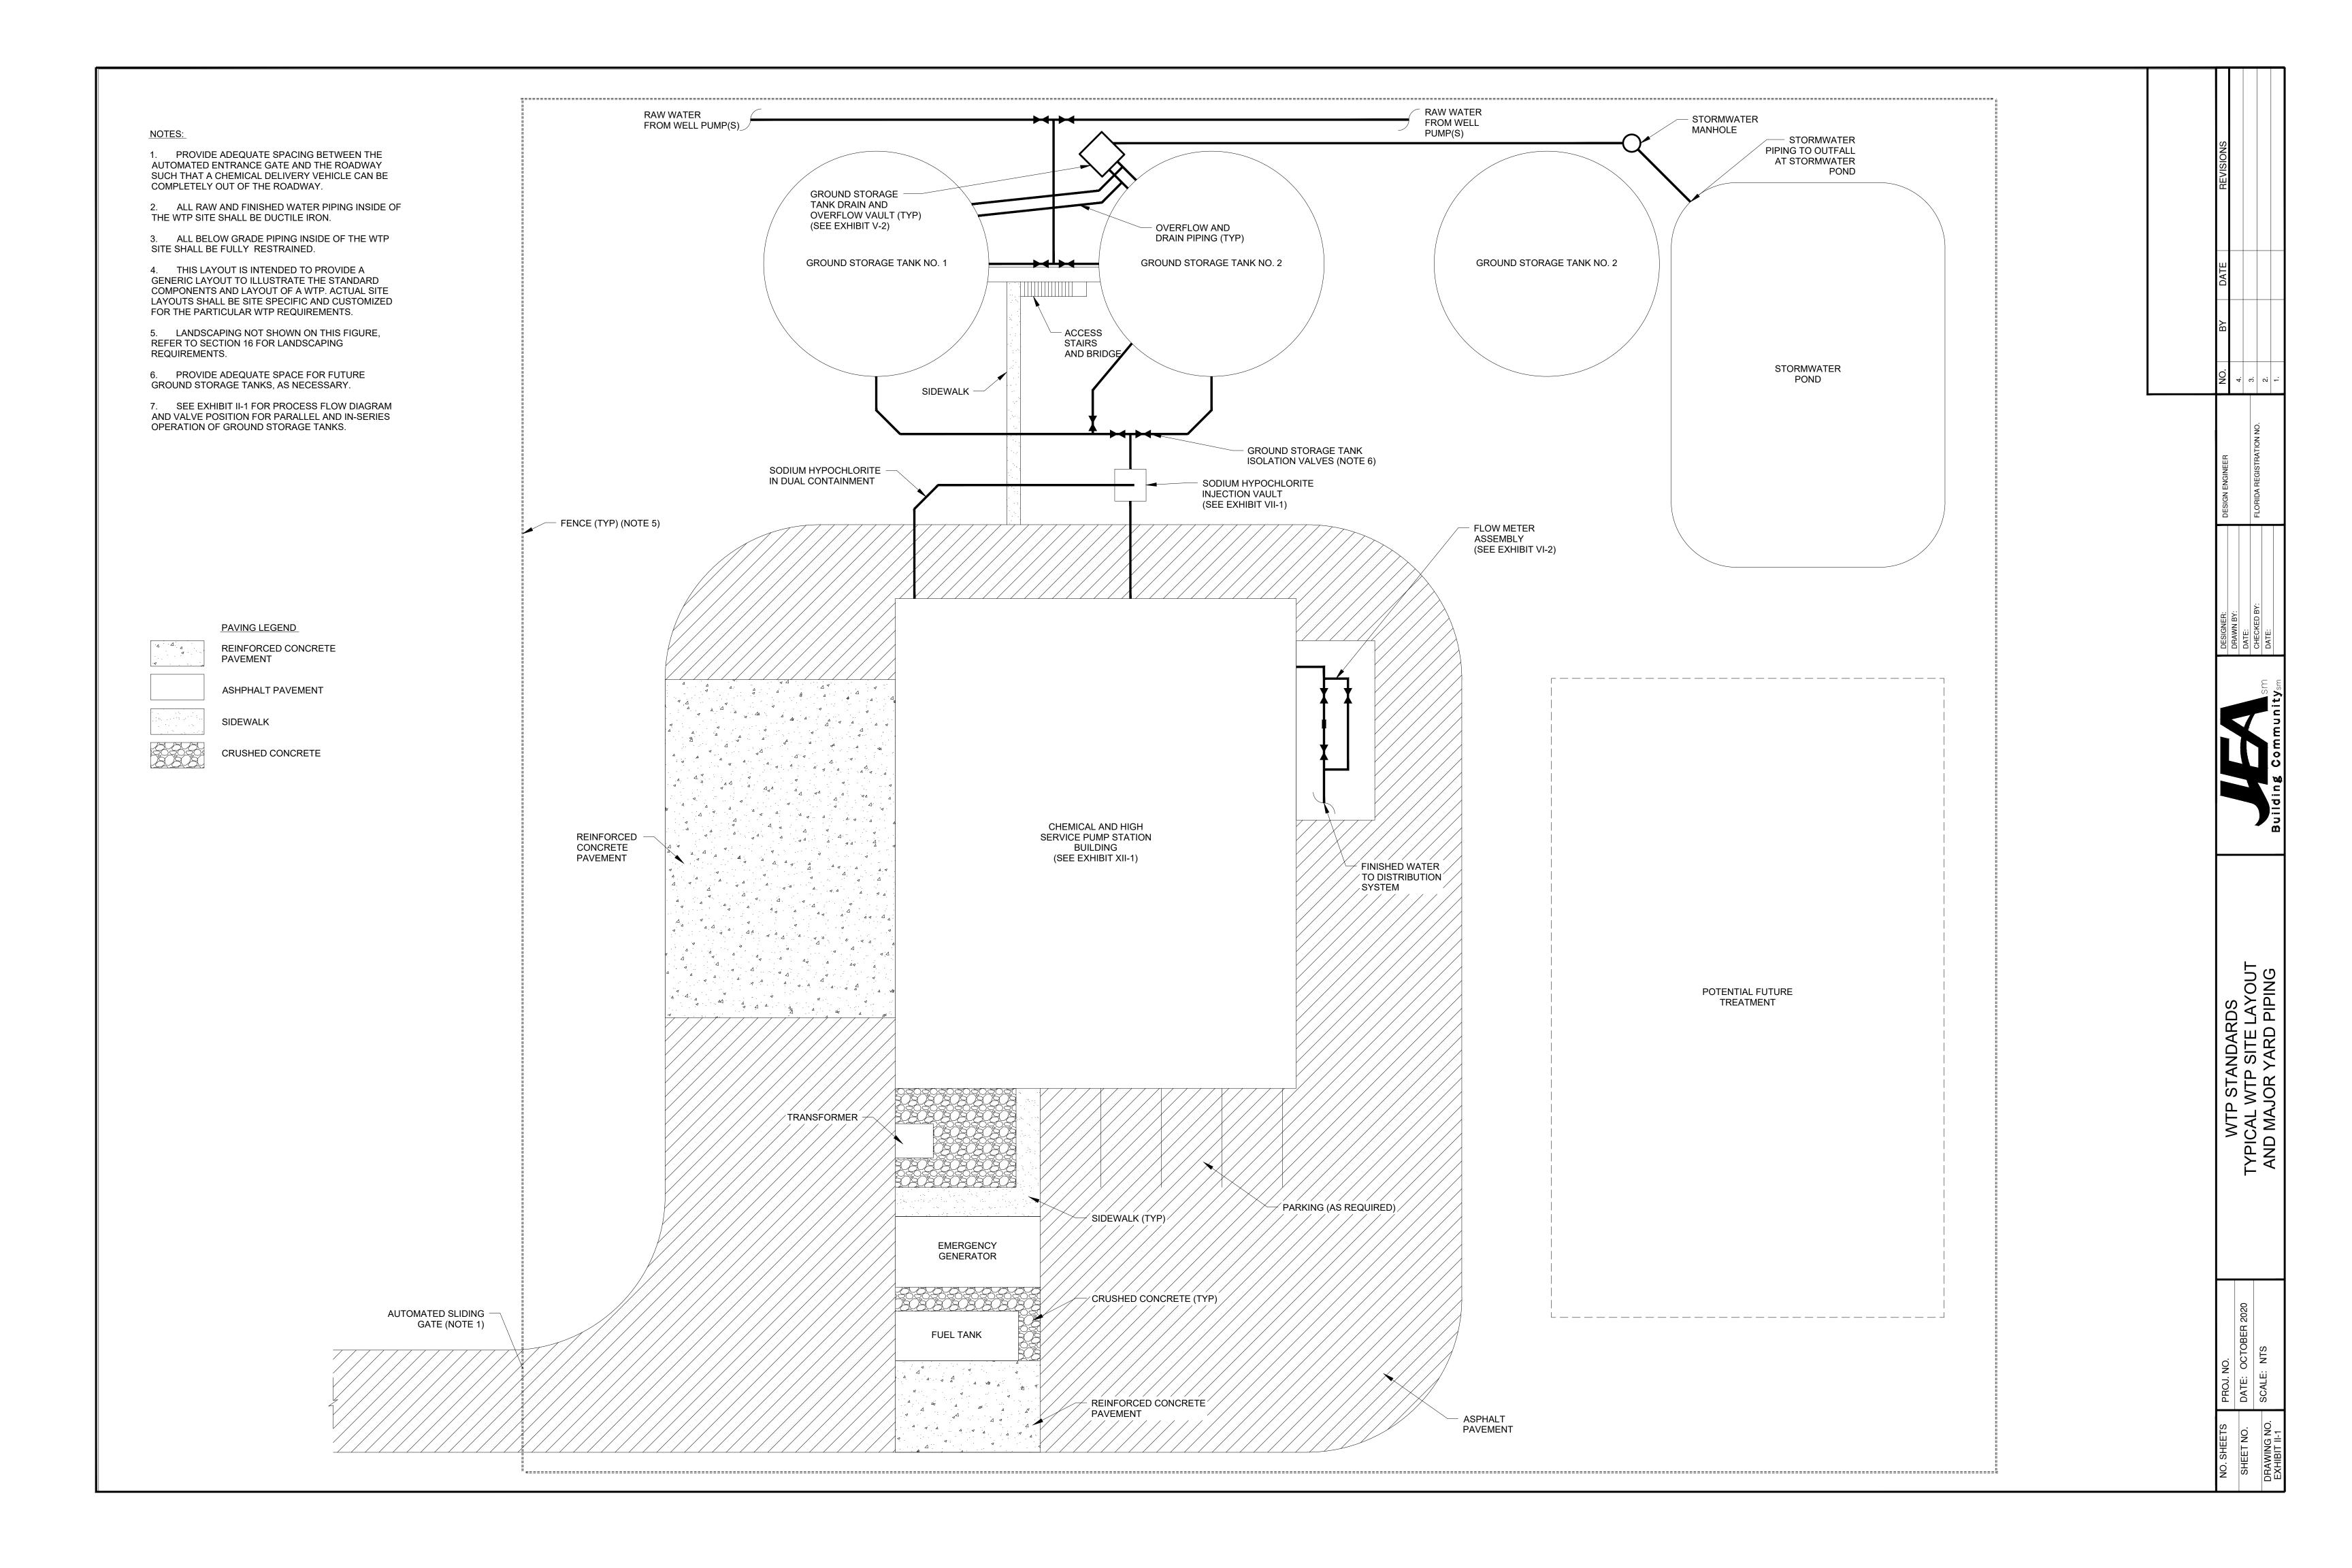


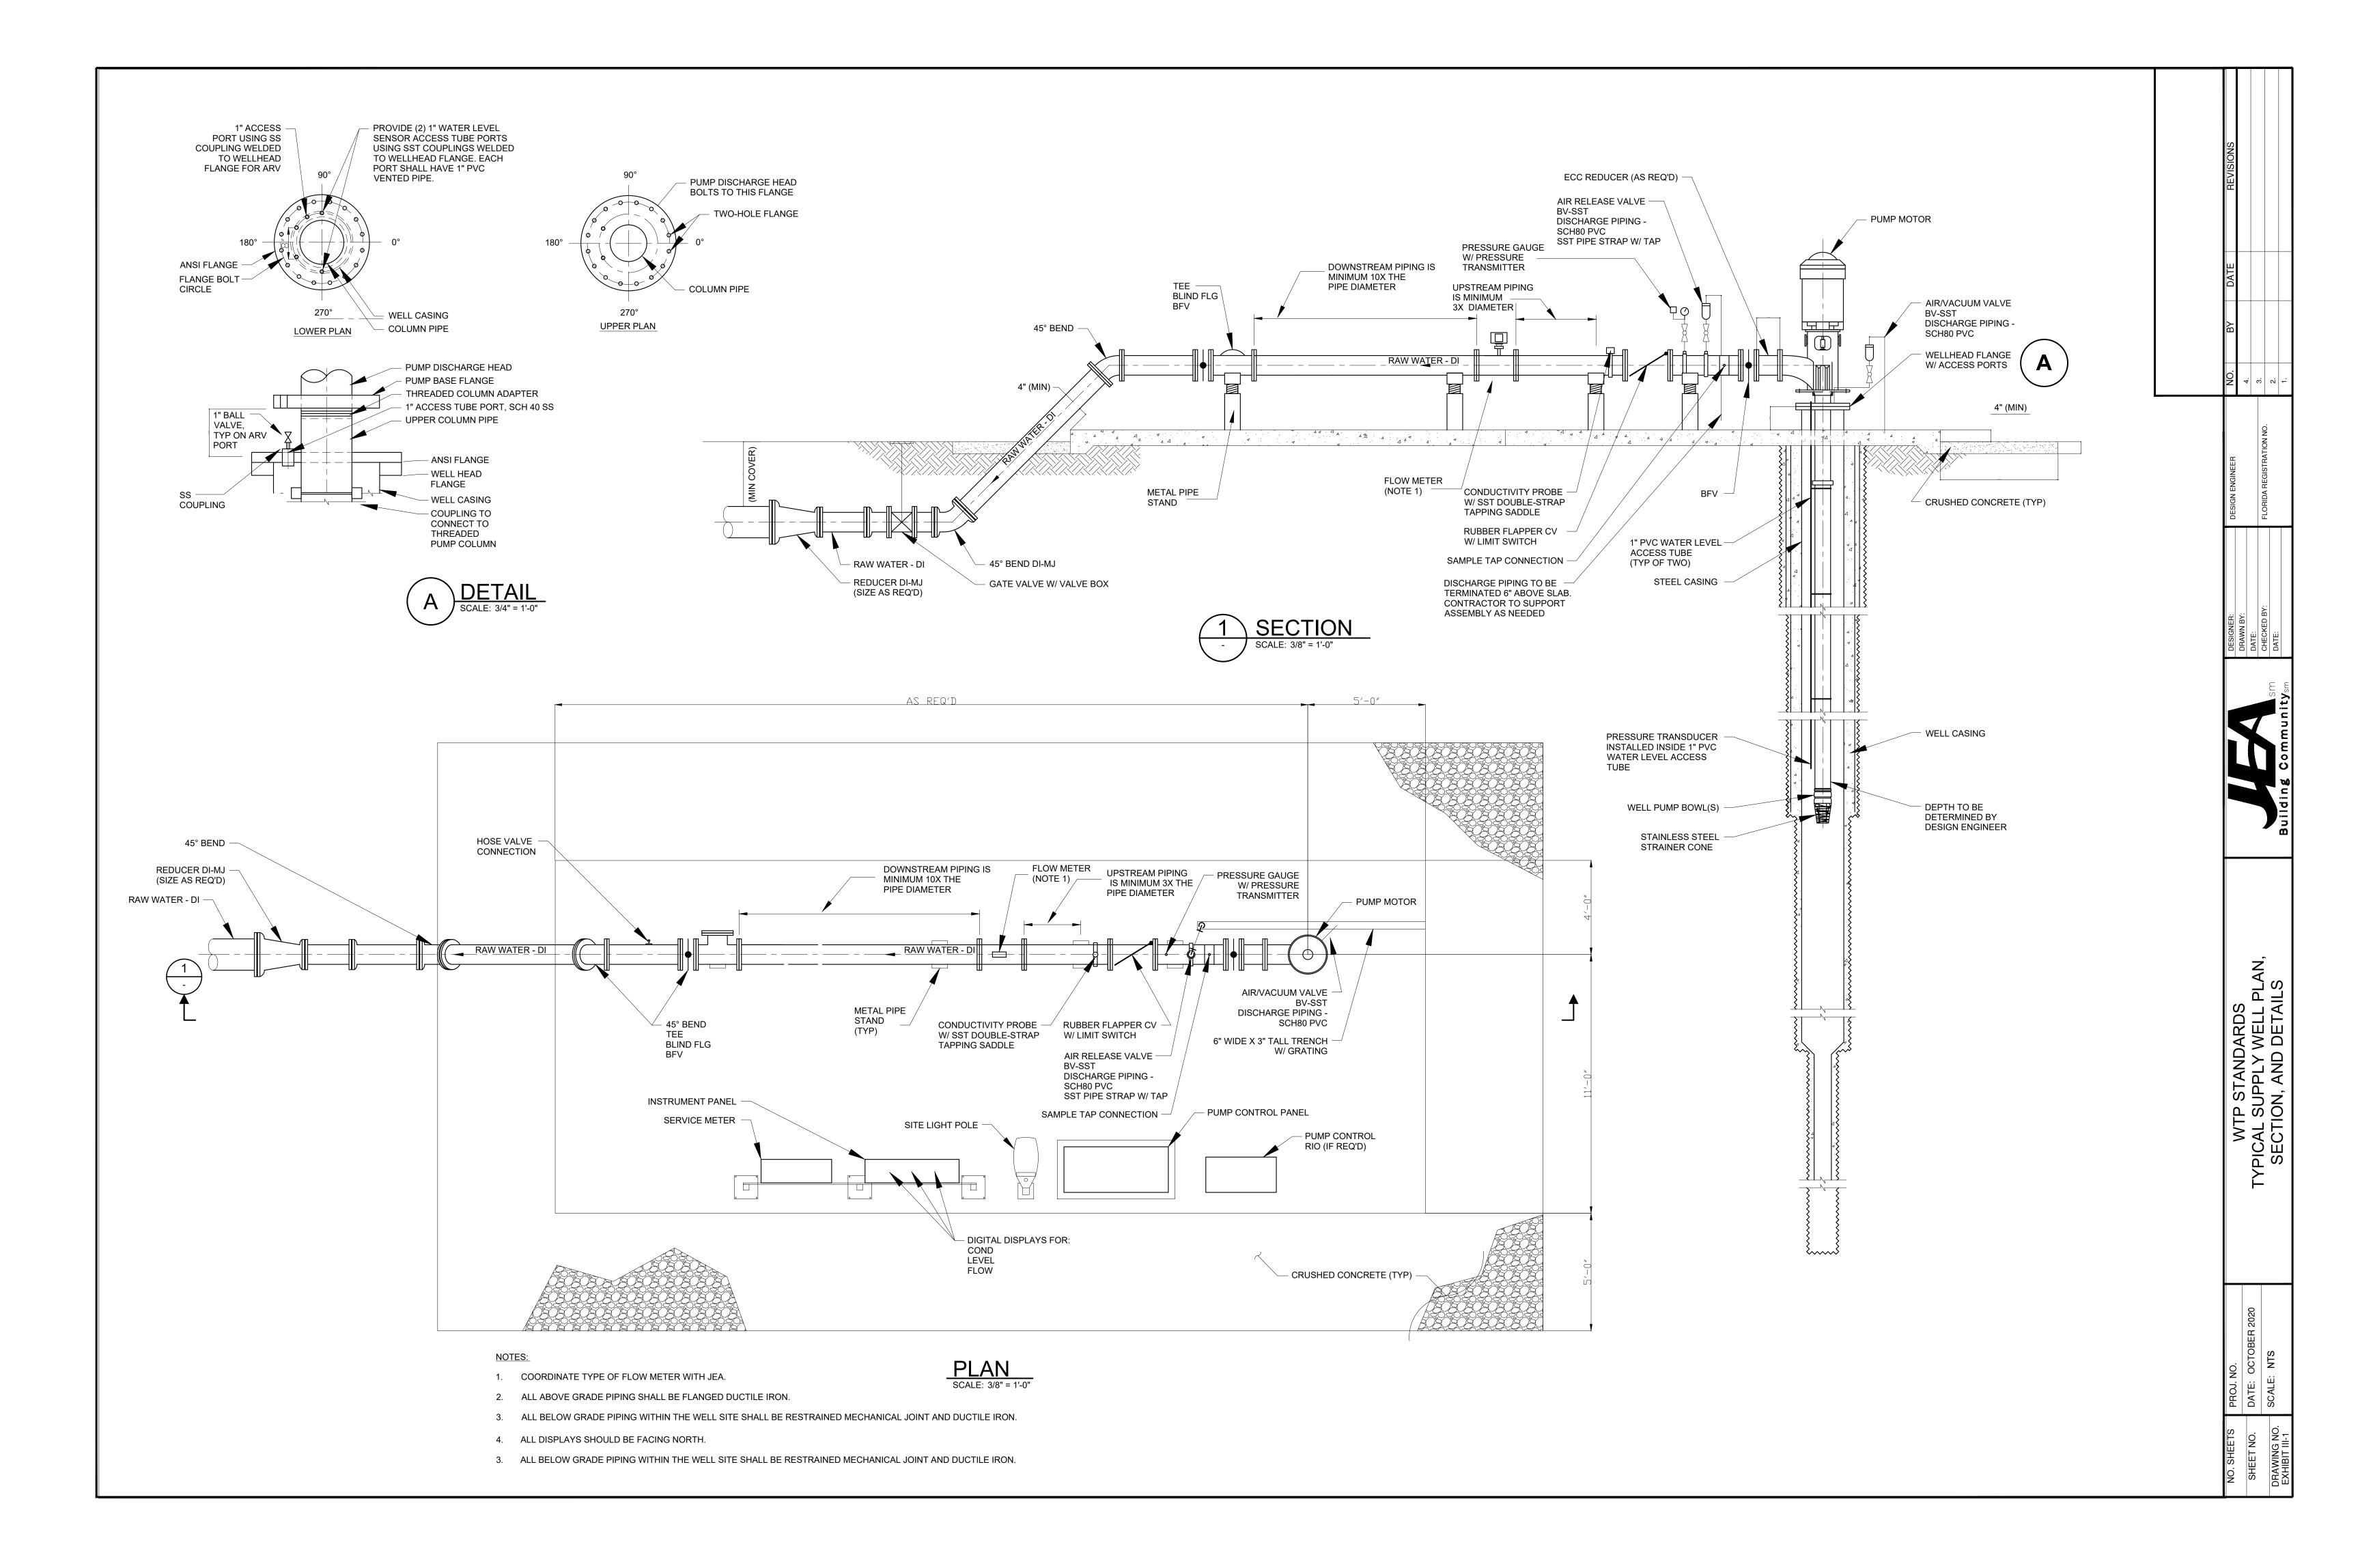

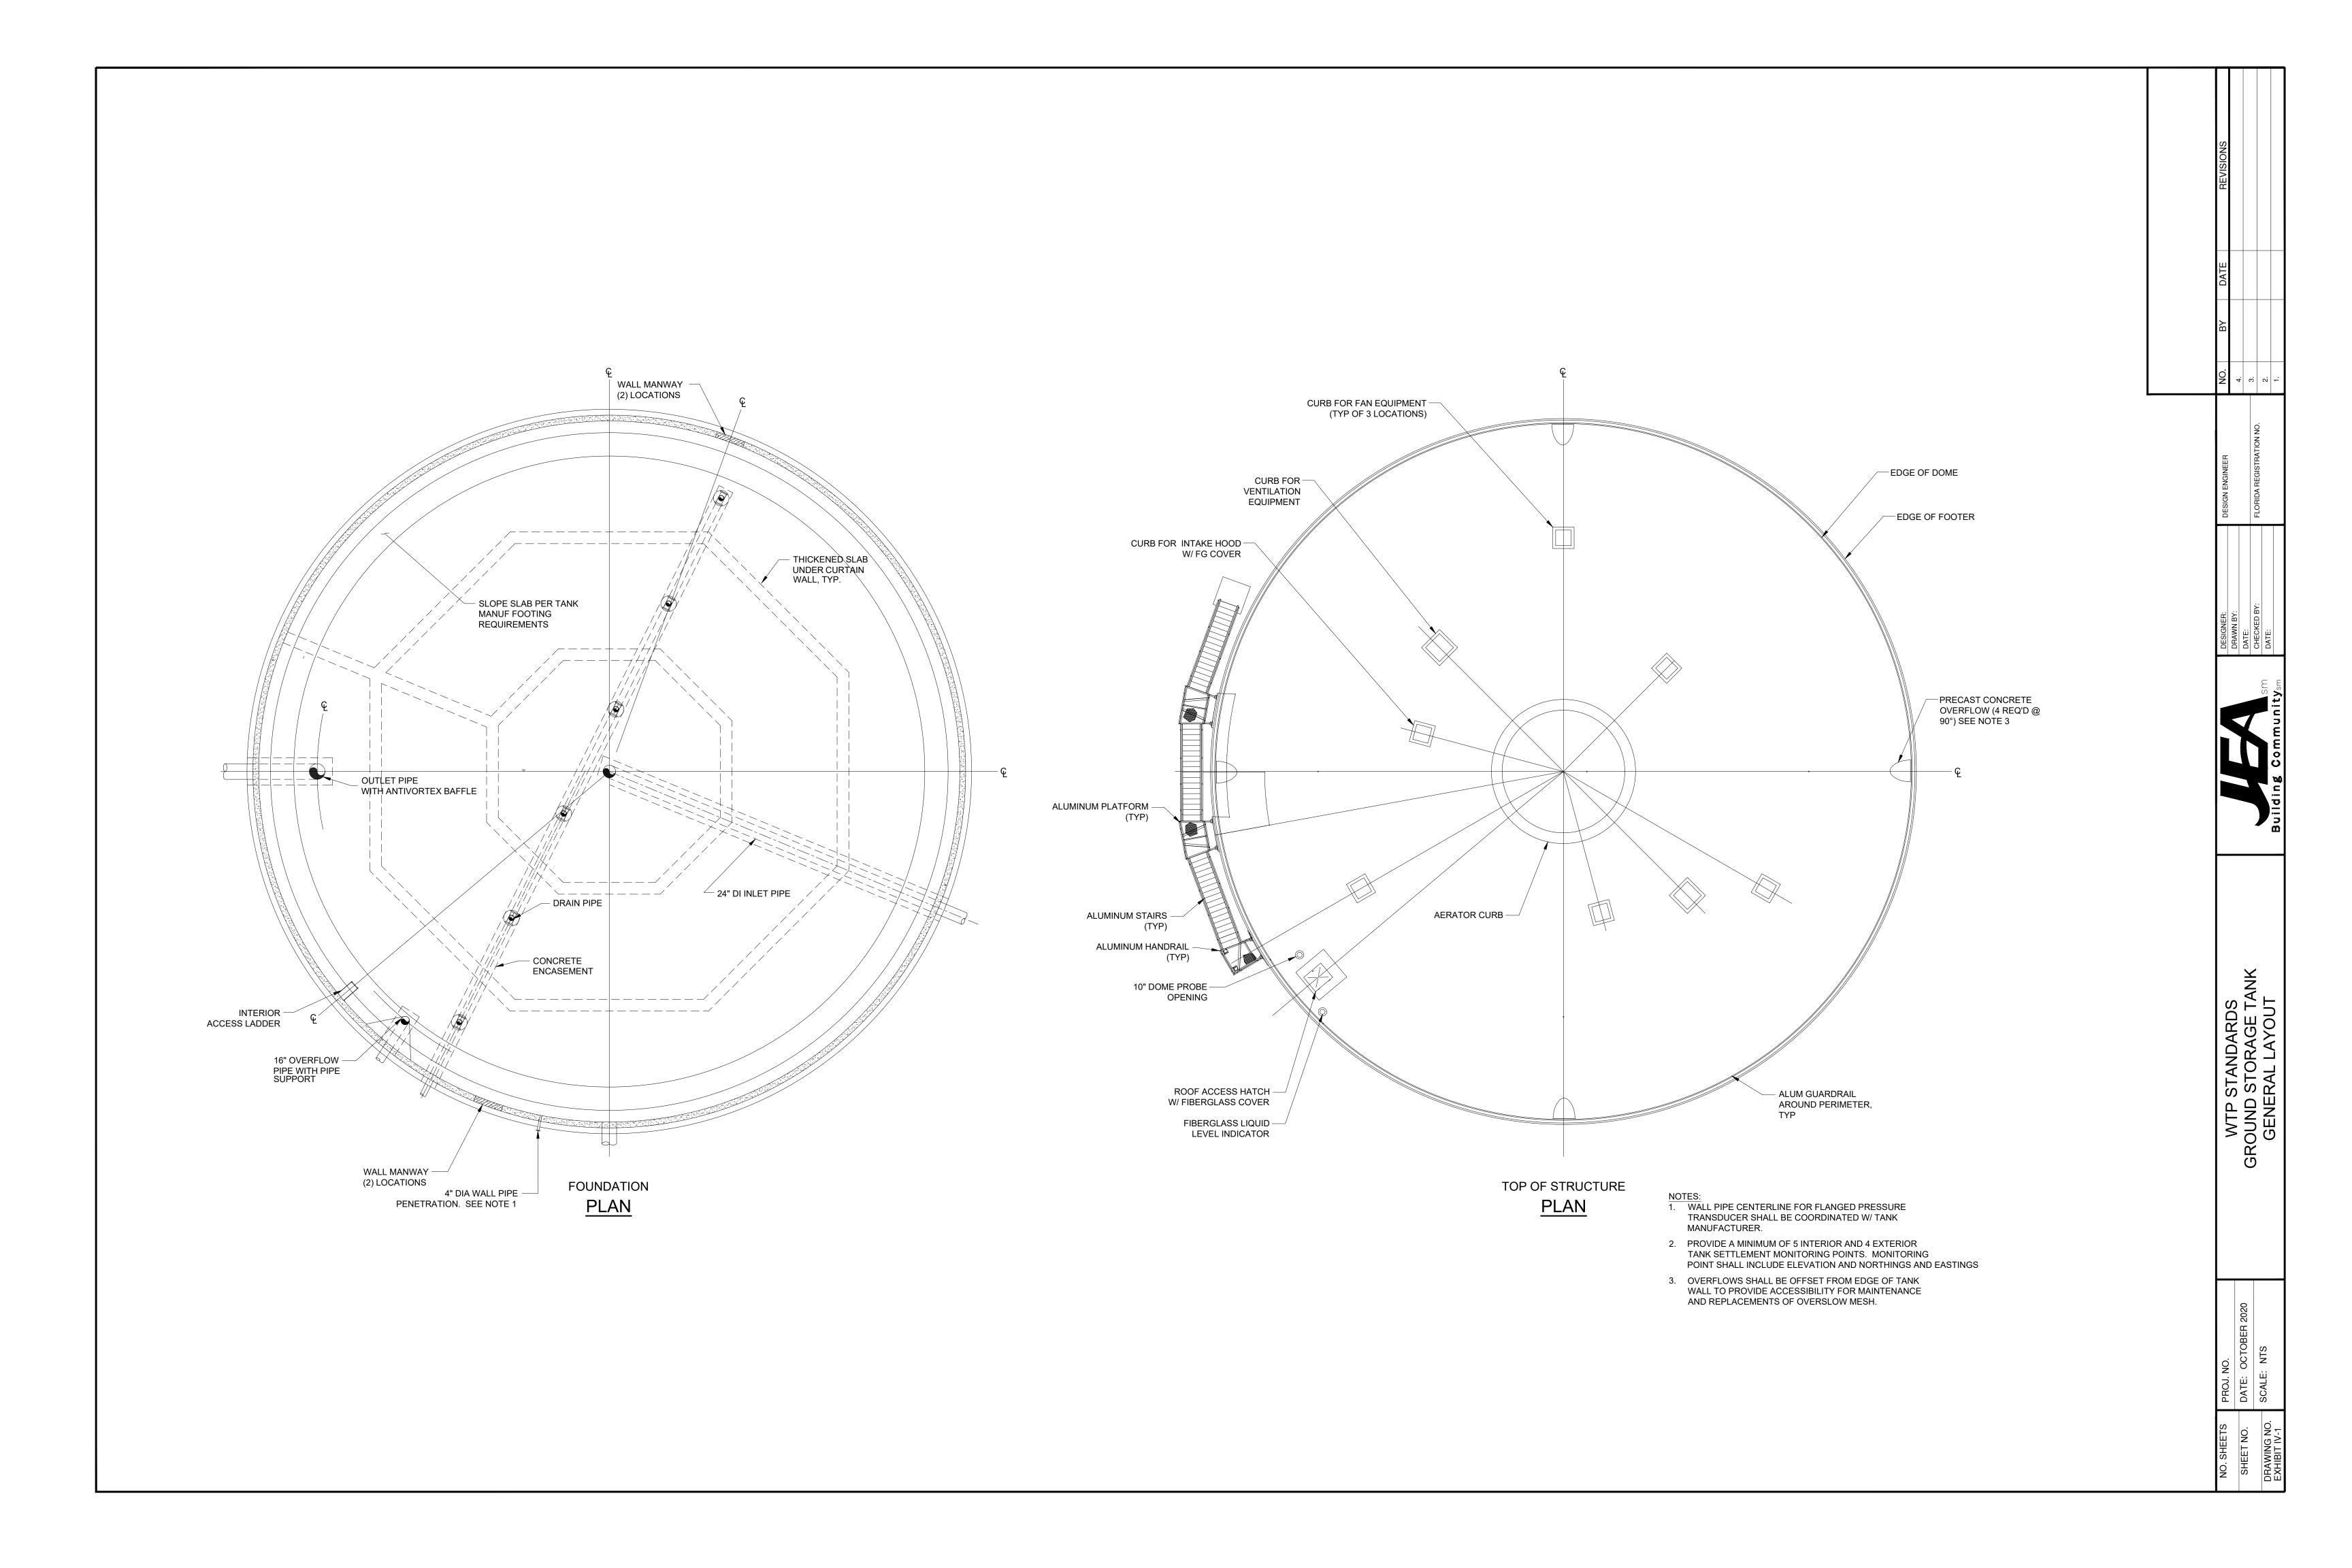

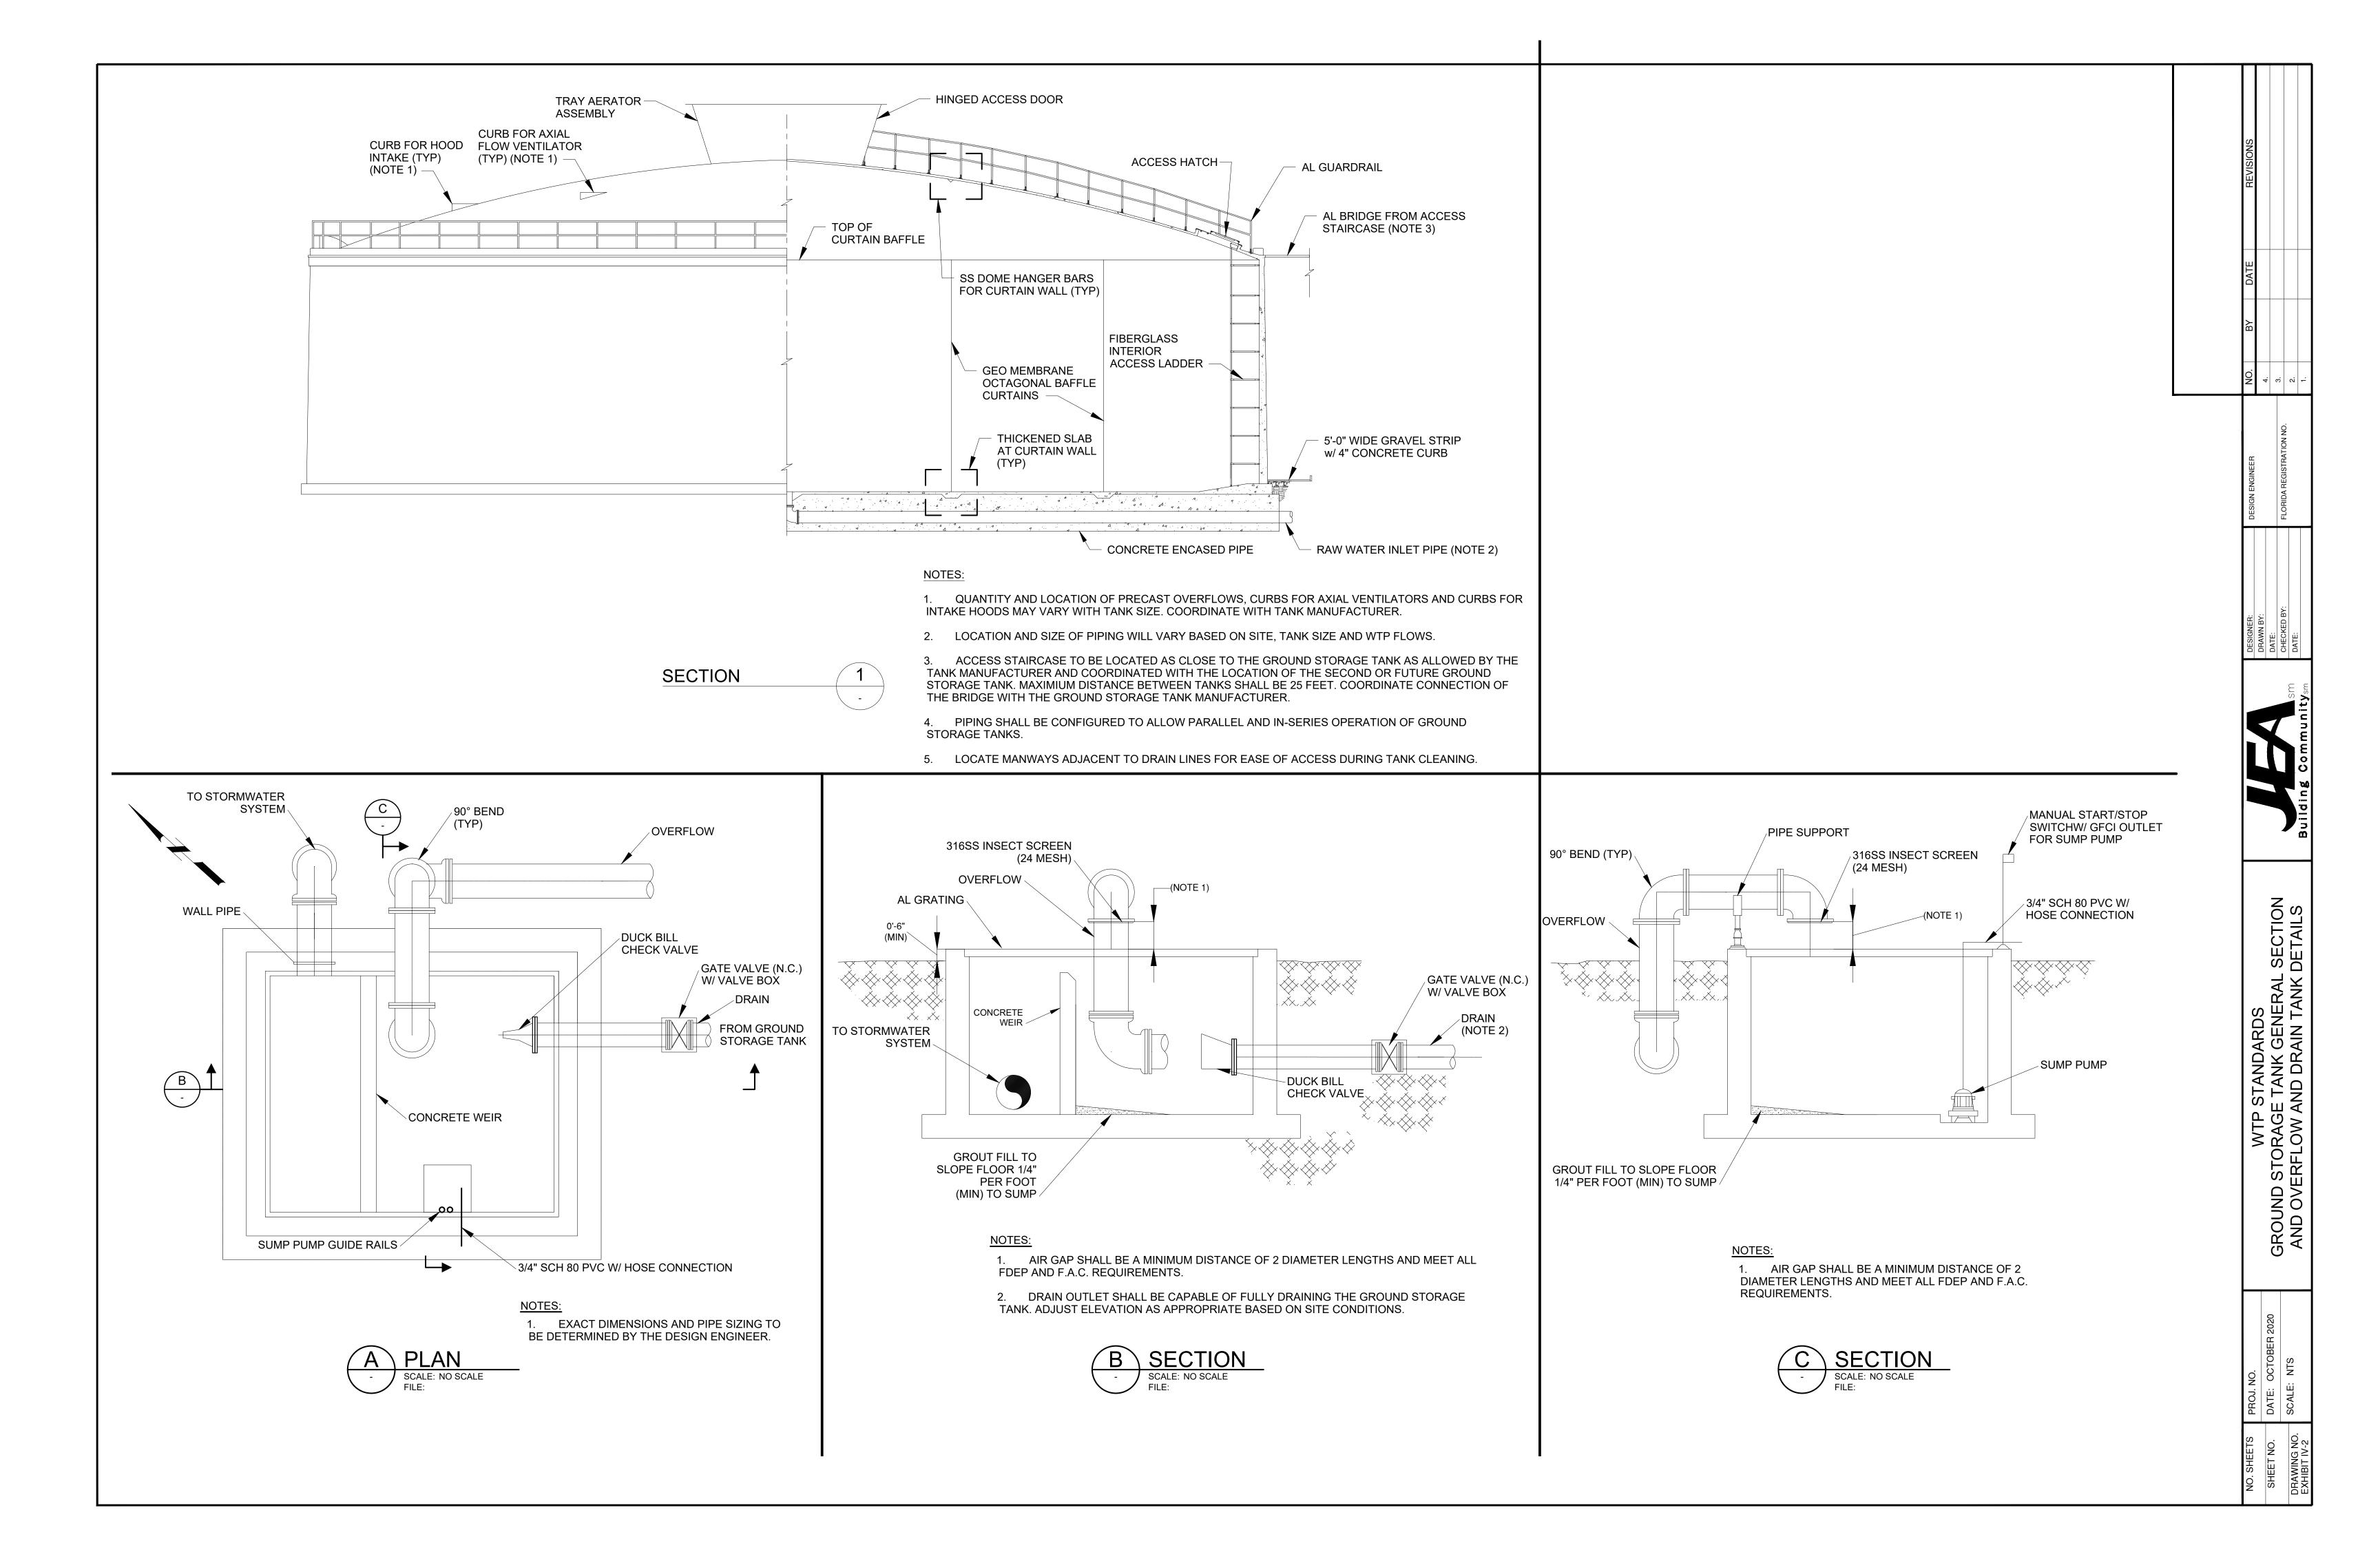

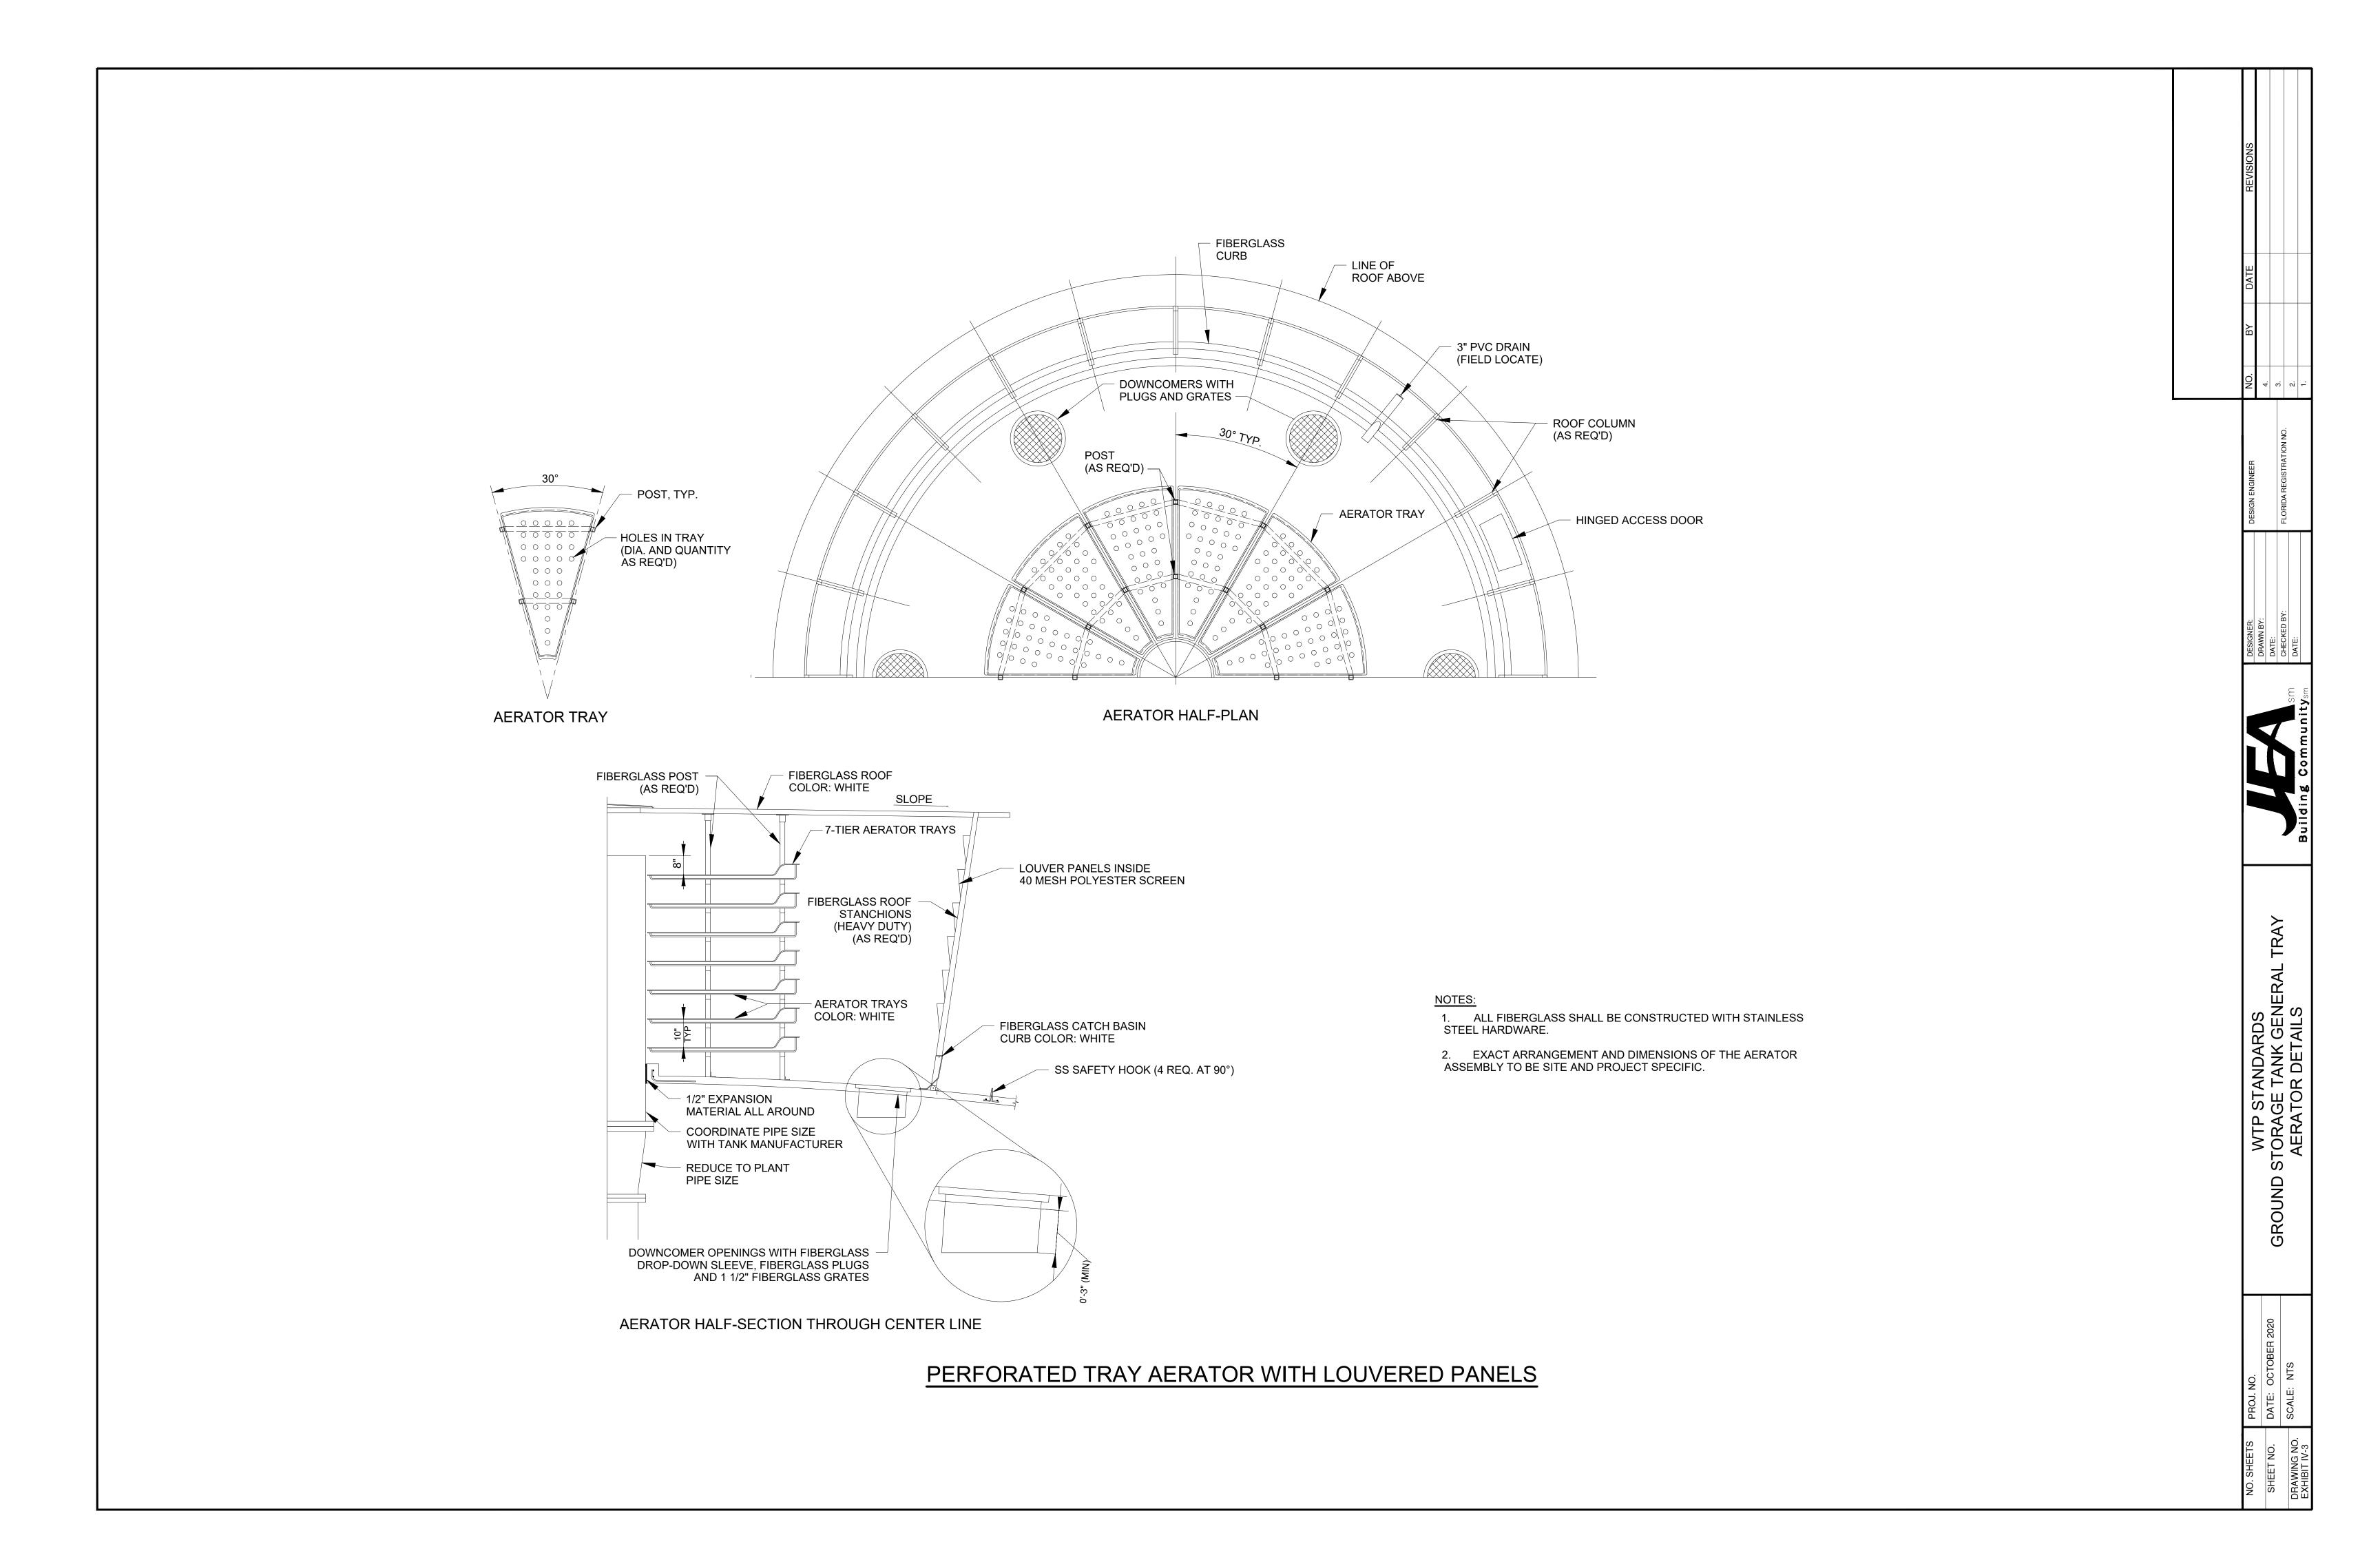


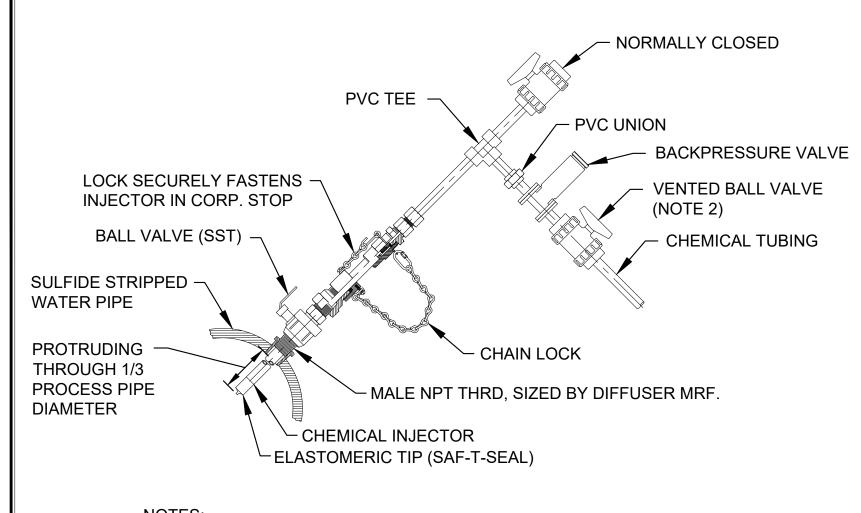

NOTES:

- 1. INJECTOR SHALL BE RETRACTABLE INJECTION QUILL WITH BALL VALVE. REFER TO JEA APPROVED MANUFACTURERS.
- 2. MATERIAL OF DIFFUSER, CONNECTIONS AND PIPING TO BE COMPATIBLE WITH CHEMICAL AND APPLICATION.
- 3. EACH CHEMICAL INJECTION SITE SHALL RECEIVE TWO INJECTORS TO PROVIDE REDUNDANCY. PIPING AND VALVES SHALL ALLOW ISOLATION OF EACH INJECTOR WHILE THE OTHER REMAINS IN SERVICE.
- 4. INJECTOR PENETRATION LOCATIONS SHALL BE STAGGERED AND SPACED SUFFICIENTLY TO ENSURE PIPE INTEGRITY IS NOT COMPROMISED AND SUFFICIENT ACCESSIBILITY IS PROVIDED.




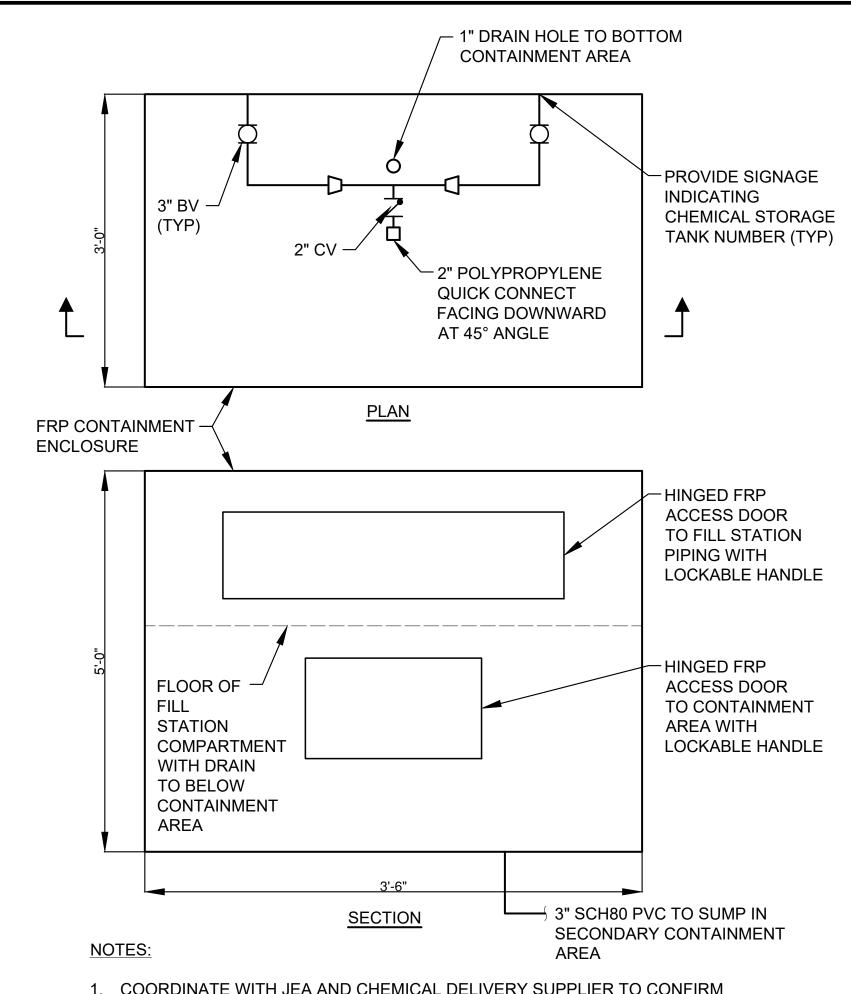

- 1. COORDINATE WITH JEA AND CHEMICAL DELIVERY SUPPLIER TO CONFIRM PIPE AND QUICK CONNECT SIZING.
- 2. SEE EXHIBIT VI-1A FOR EXAMPLE CHEMICAL FILL STATION.

CHEMICAL FILL STATION

NTS

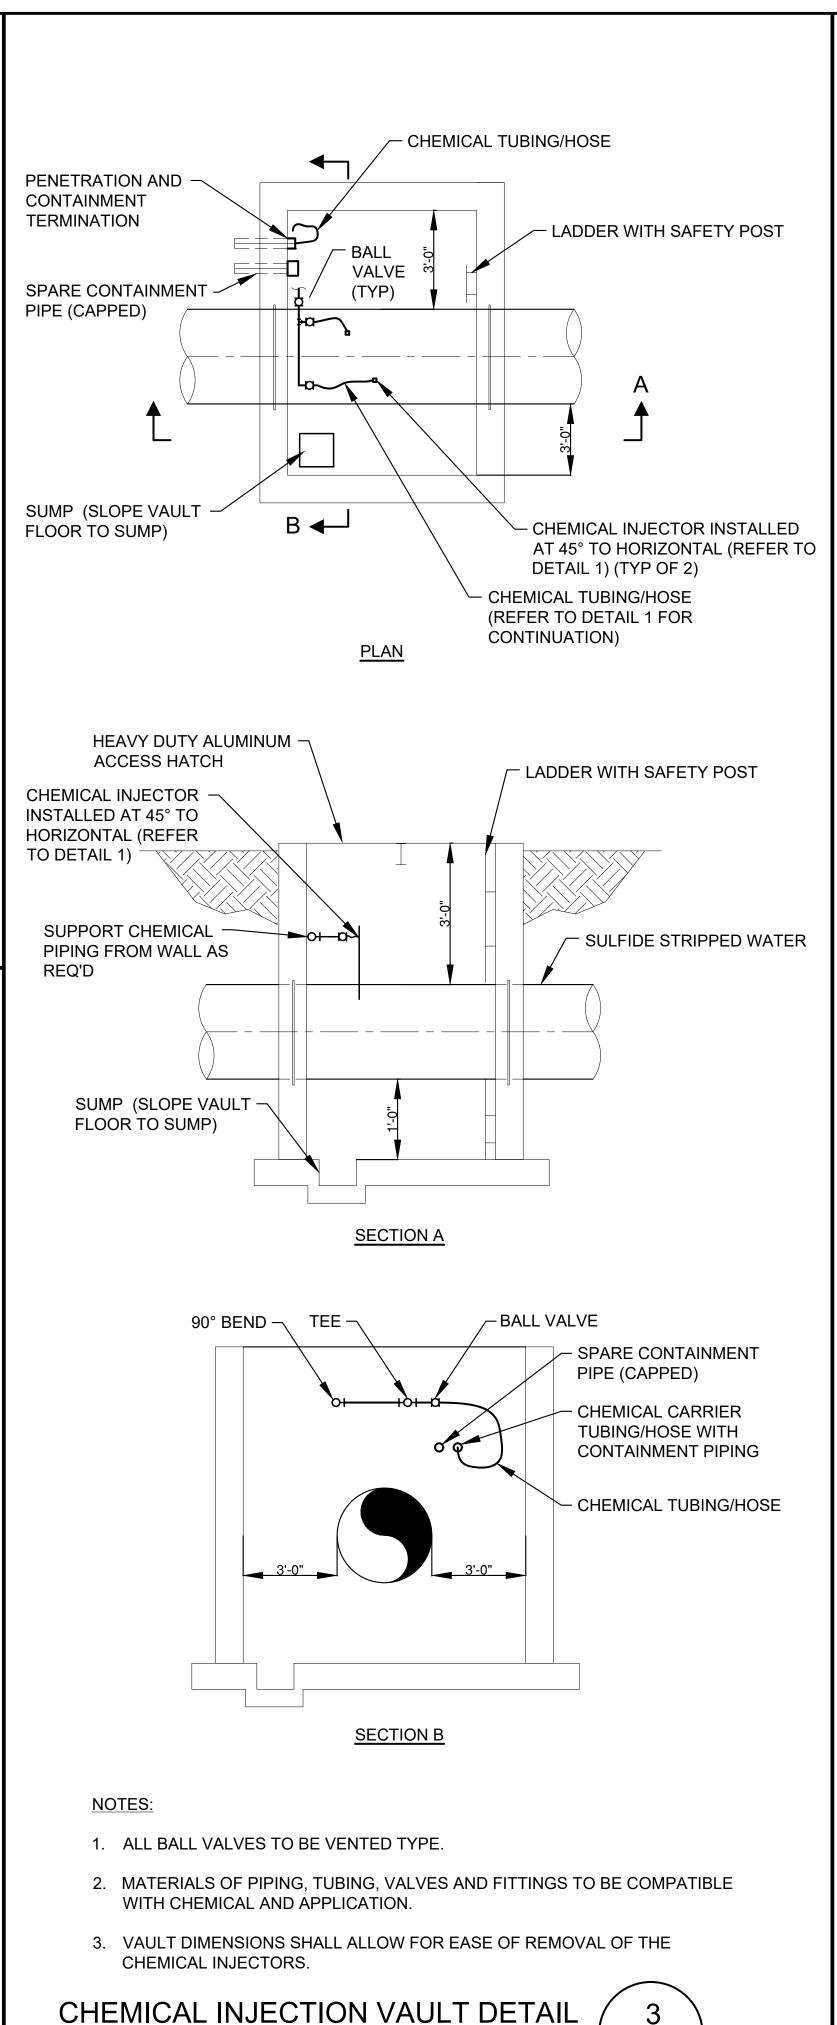

NOTES:

1. CABINETRY SHALL INCLUDE A SLIDING DOOR TO PROVIDE FULL ACCESS TO SAMPLE PIPING. ADEQUATE LIGHTING SHALL BE

PLASTIC MOUNTING

pH/CHLORINE

PROBES -

TUBING

2'-0"

1/8" BV

1/8" BV

1/8" PVC TUBING —

1/2" PRV (PG)

1/2" BV (NC)

ROTAMETER

1/2" STRAINER

DRAIN

12'-0" MIN

(SST)

💢 1/2" BV

BRACKET (TYP 2)

(NOTE 3)

SHELF FOR

REAGENTS

(NOTE 2)

TYPE 1 - pH AND FREE

pH/CHLORINE

PROBES

1/2" BV (NC) 🕻

ROTAMETER \

1/2" BV

SST

1/2" BRAIDED PVC

COUNTER TOP

TUBING

TUBING

CHLORINE ANALYZER STATION

pH/CHLORINE

ANALYZER AND

TRANSMITTER

1/2" BRAIDED PVC

TUBING

(PG) 1/2" PRV

3/4" BV 💭

1/2" STRAINER 1/2" BV

1/2" BV

3/4" BV 3/4" BV (NC)

2'-0"

2. TYPICAL SHELF SHALL BE WALL MOUNTED AND 18" WIDE X 3" TALL X 4" DEPTH.

FINISHED WATER FROM HIGH SERVICE PUMP STATION

- 4. SEE EXHIBIT VII-1A FOR EXAMPLE pH AND FREE CHLORINE SAMPLE AND ANALYZER STATION.

pH AND FREE CHLORINE SAMPLE AND ANALYZER STATION



TYPE 2 - pH AND FREE **CHLORINE ANALYZER STATION** pH/CHLORINE ANALYZER AND TRANSMITTER (SST) 1/8" BV (SST) (NC) 1/8" PVC TUBING - CABINETRY (NOTE 1) WTP STANDARDS ODIUM HYPOCHLORITE INJE SAMPLE STATION DETA FLOOR

- PROVIDED WITHIN THE CABINETRY.
- 3. COORDINATE SIZE OF PLASTIC MOUNTING BRACKET WITH PROBE AND ANALYZER SIZES.



CHEMICAL FILL STATION PIPING




CHEMICAL FILL STATION


NTS





pH AND FREE CHLORINE SAMPLE AND ANALYZER STATION 2


NO.	4.	ď	'n	2.	1
BY					
DATE					
REVISIONS					

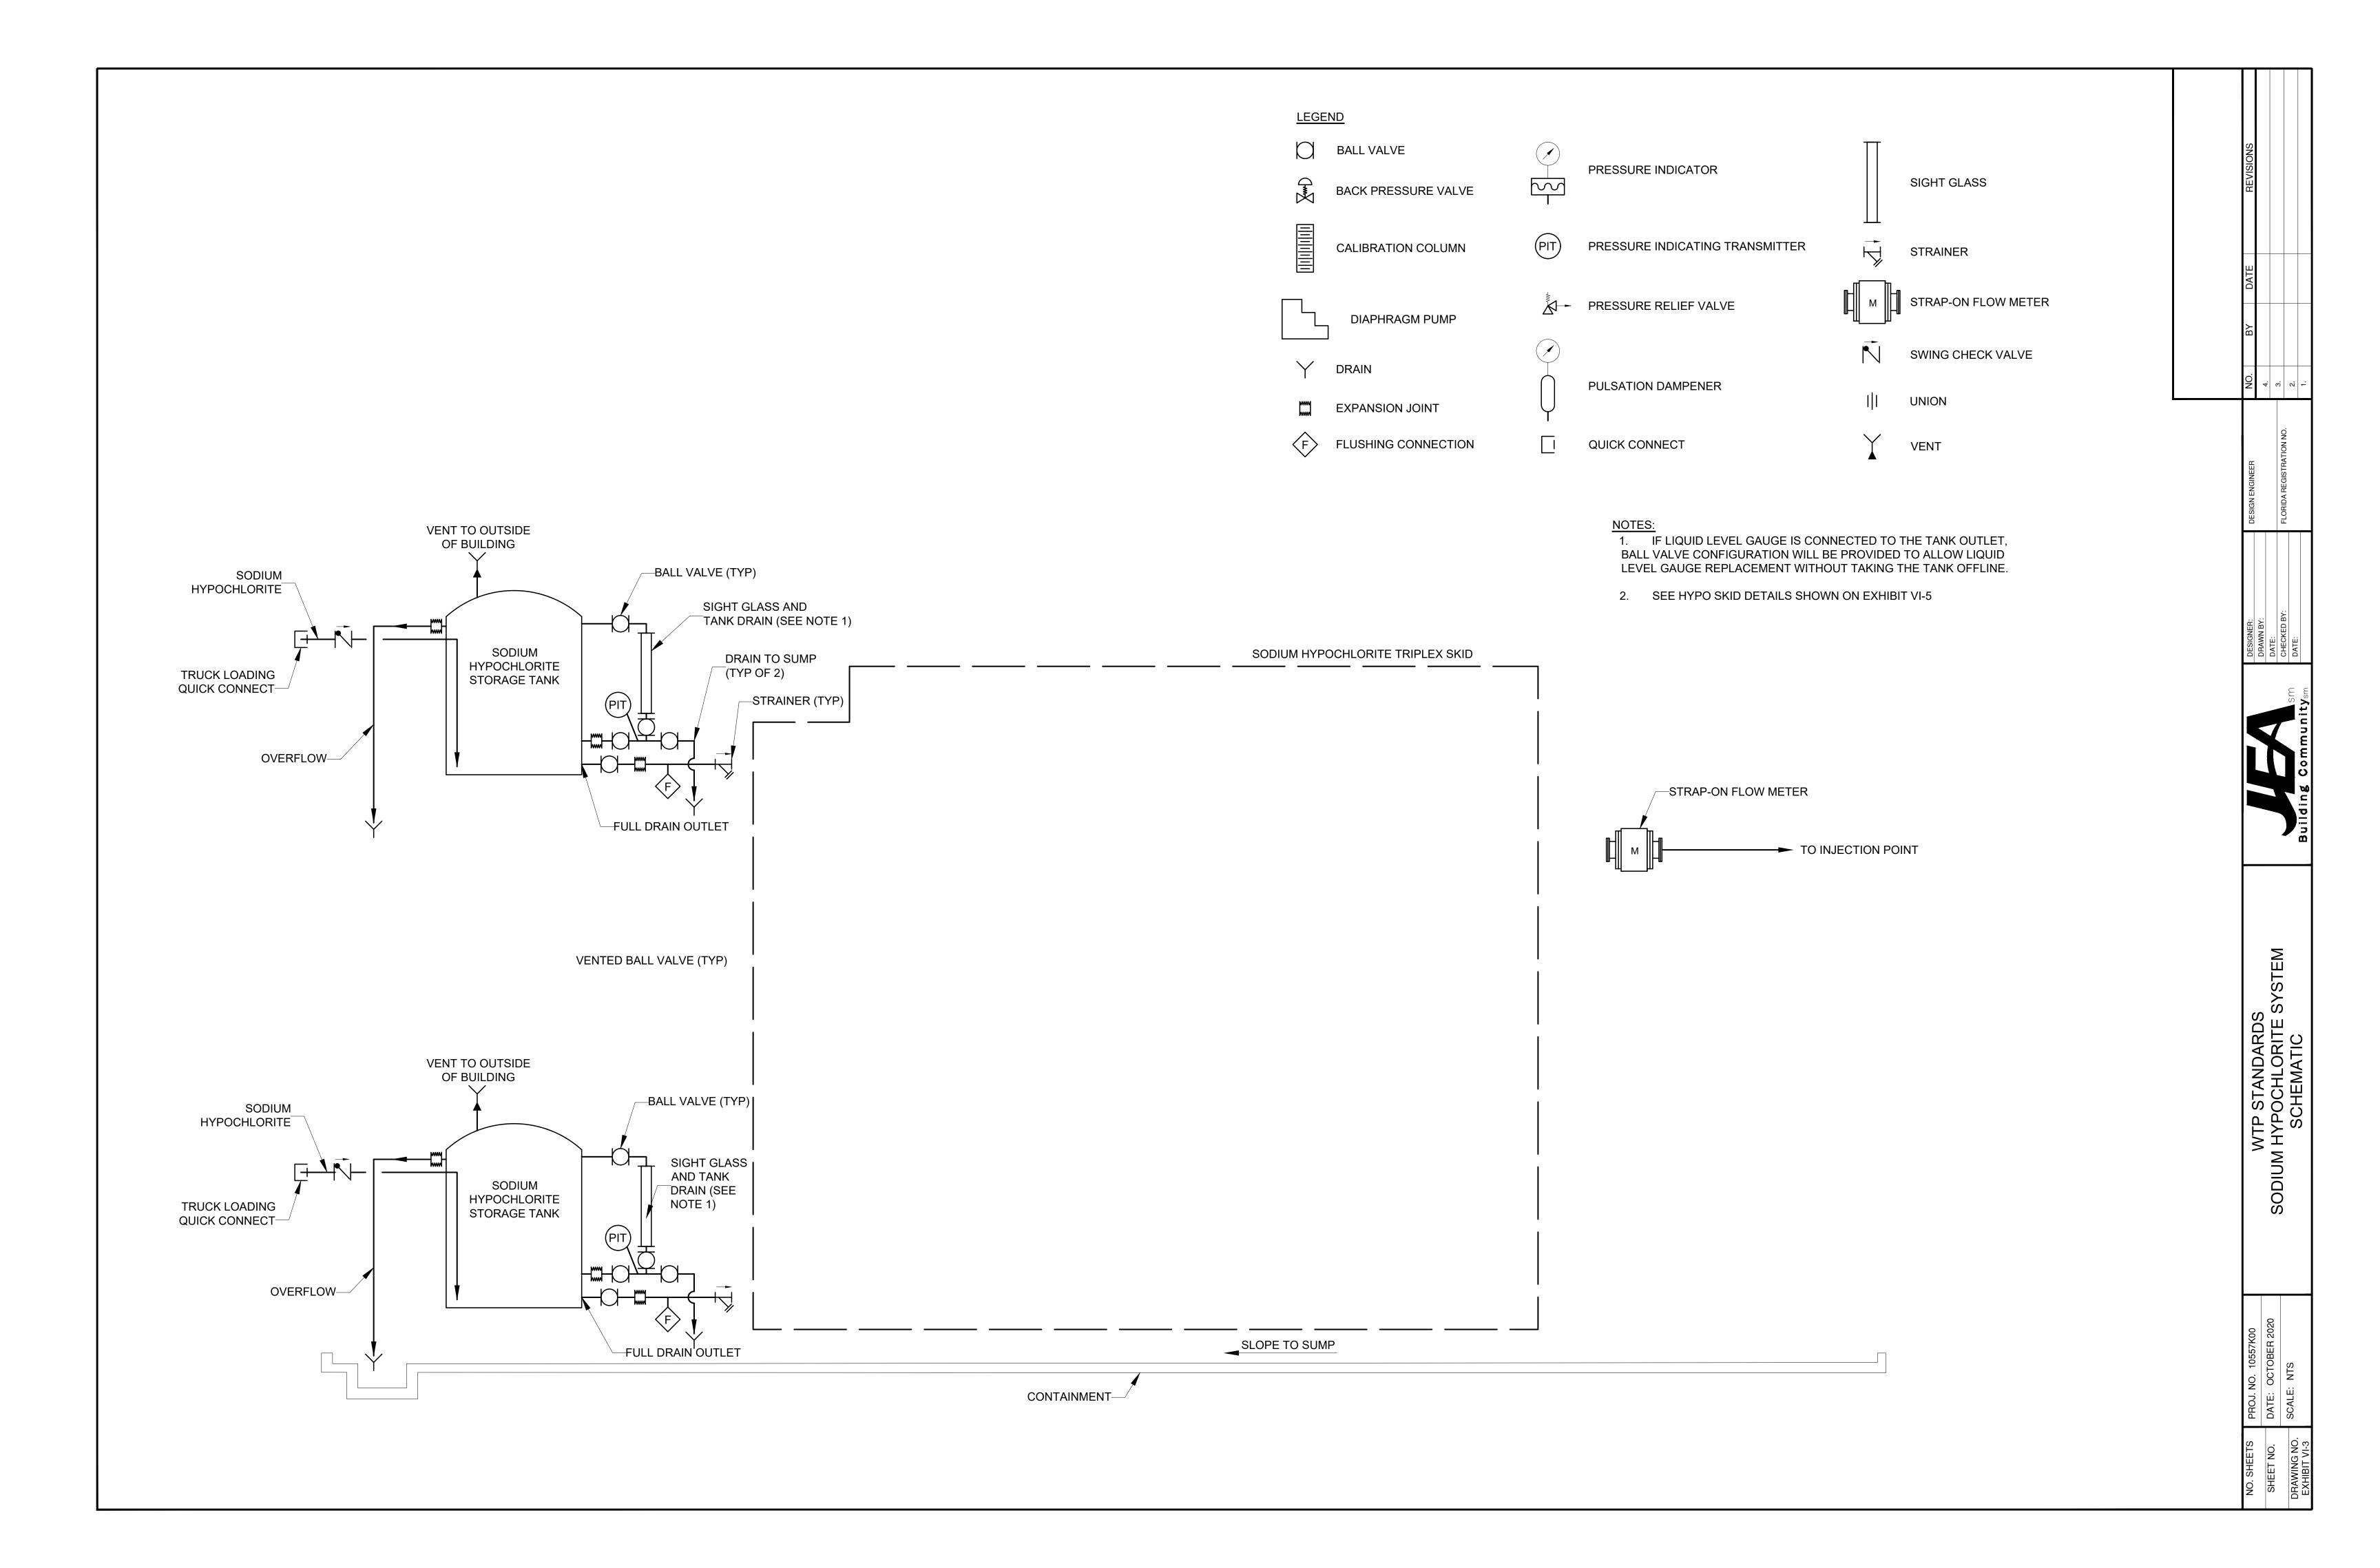


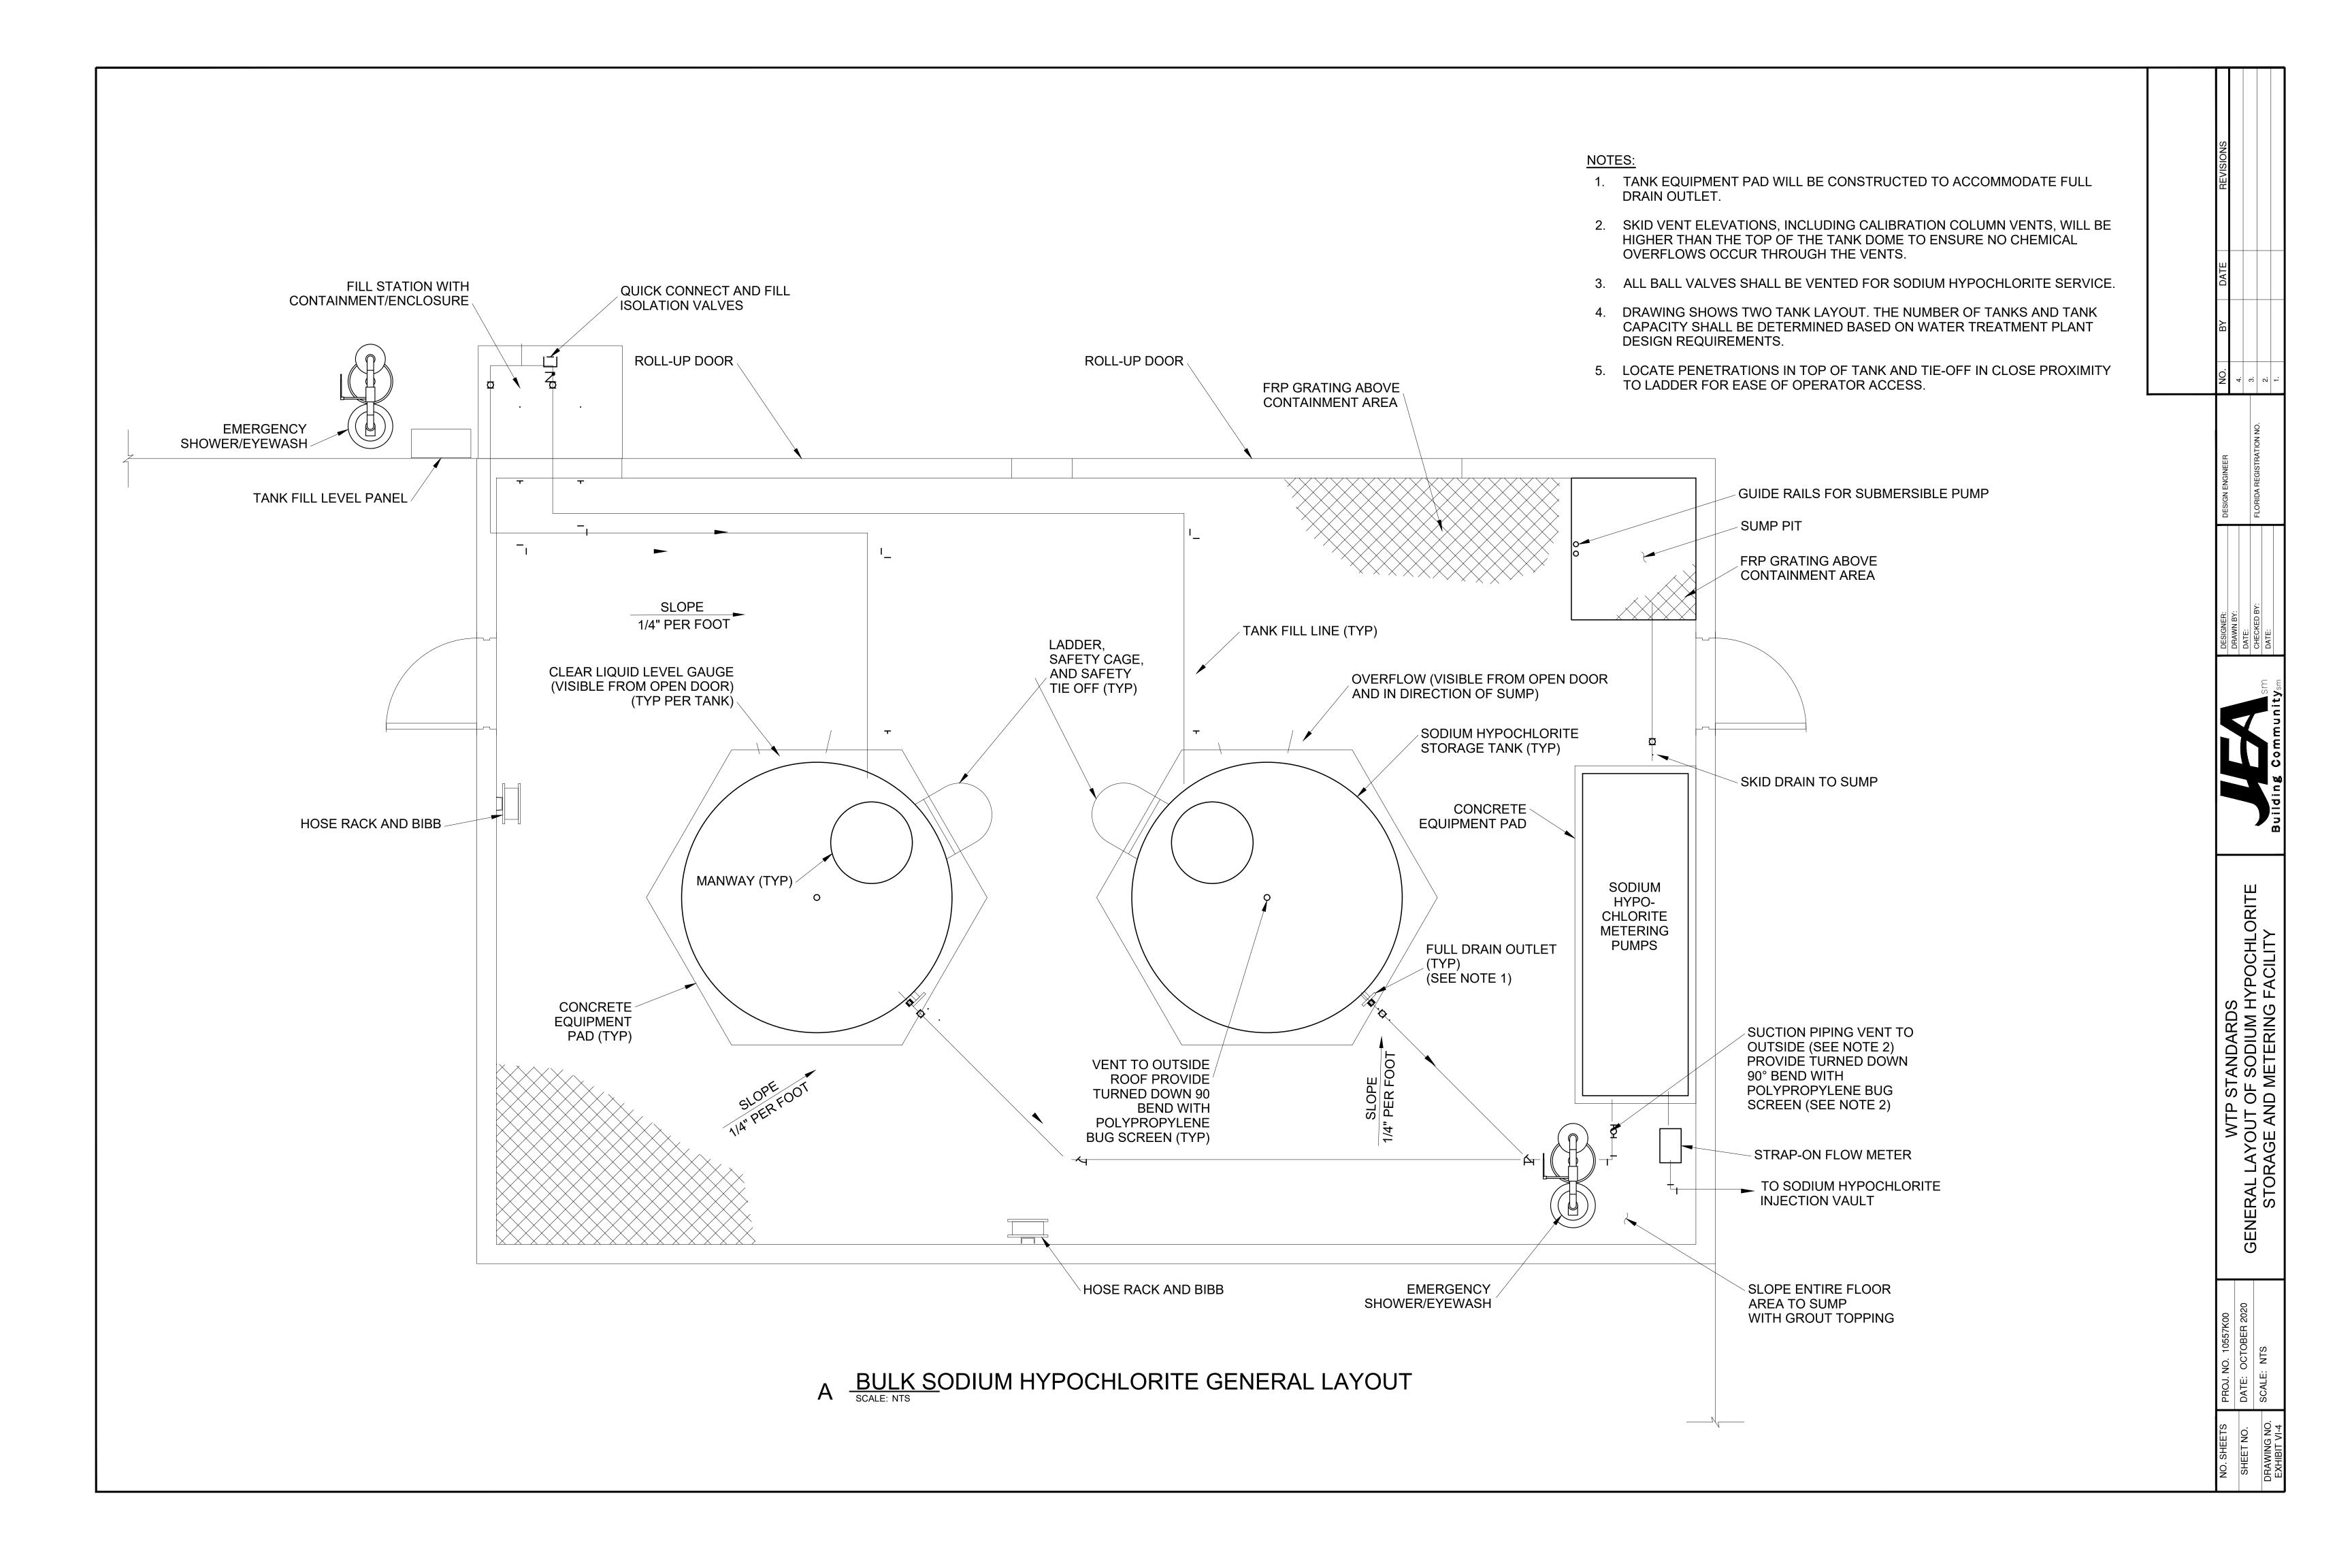


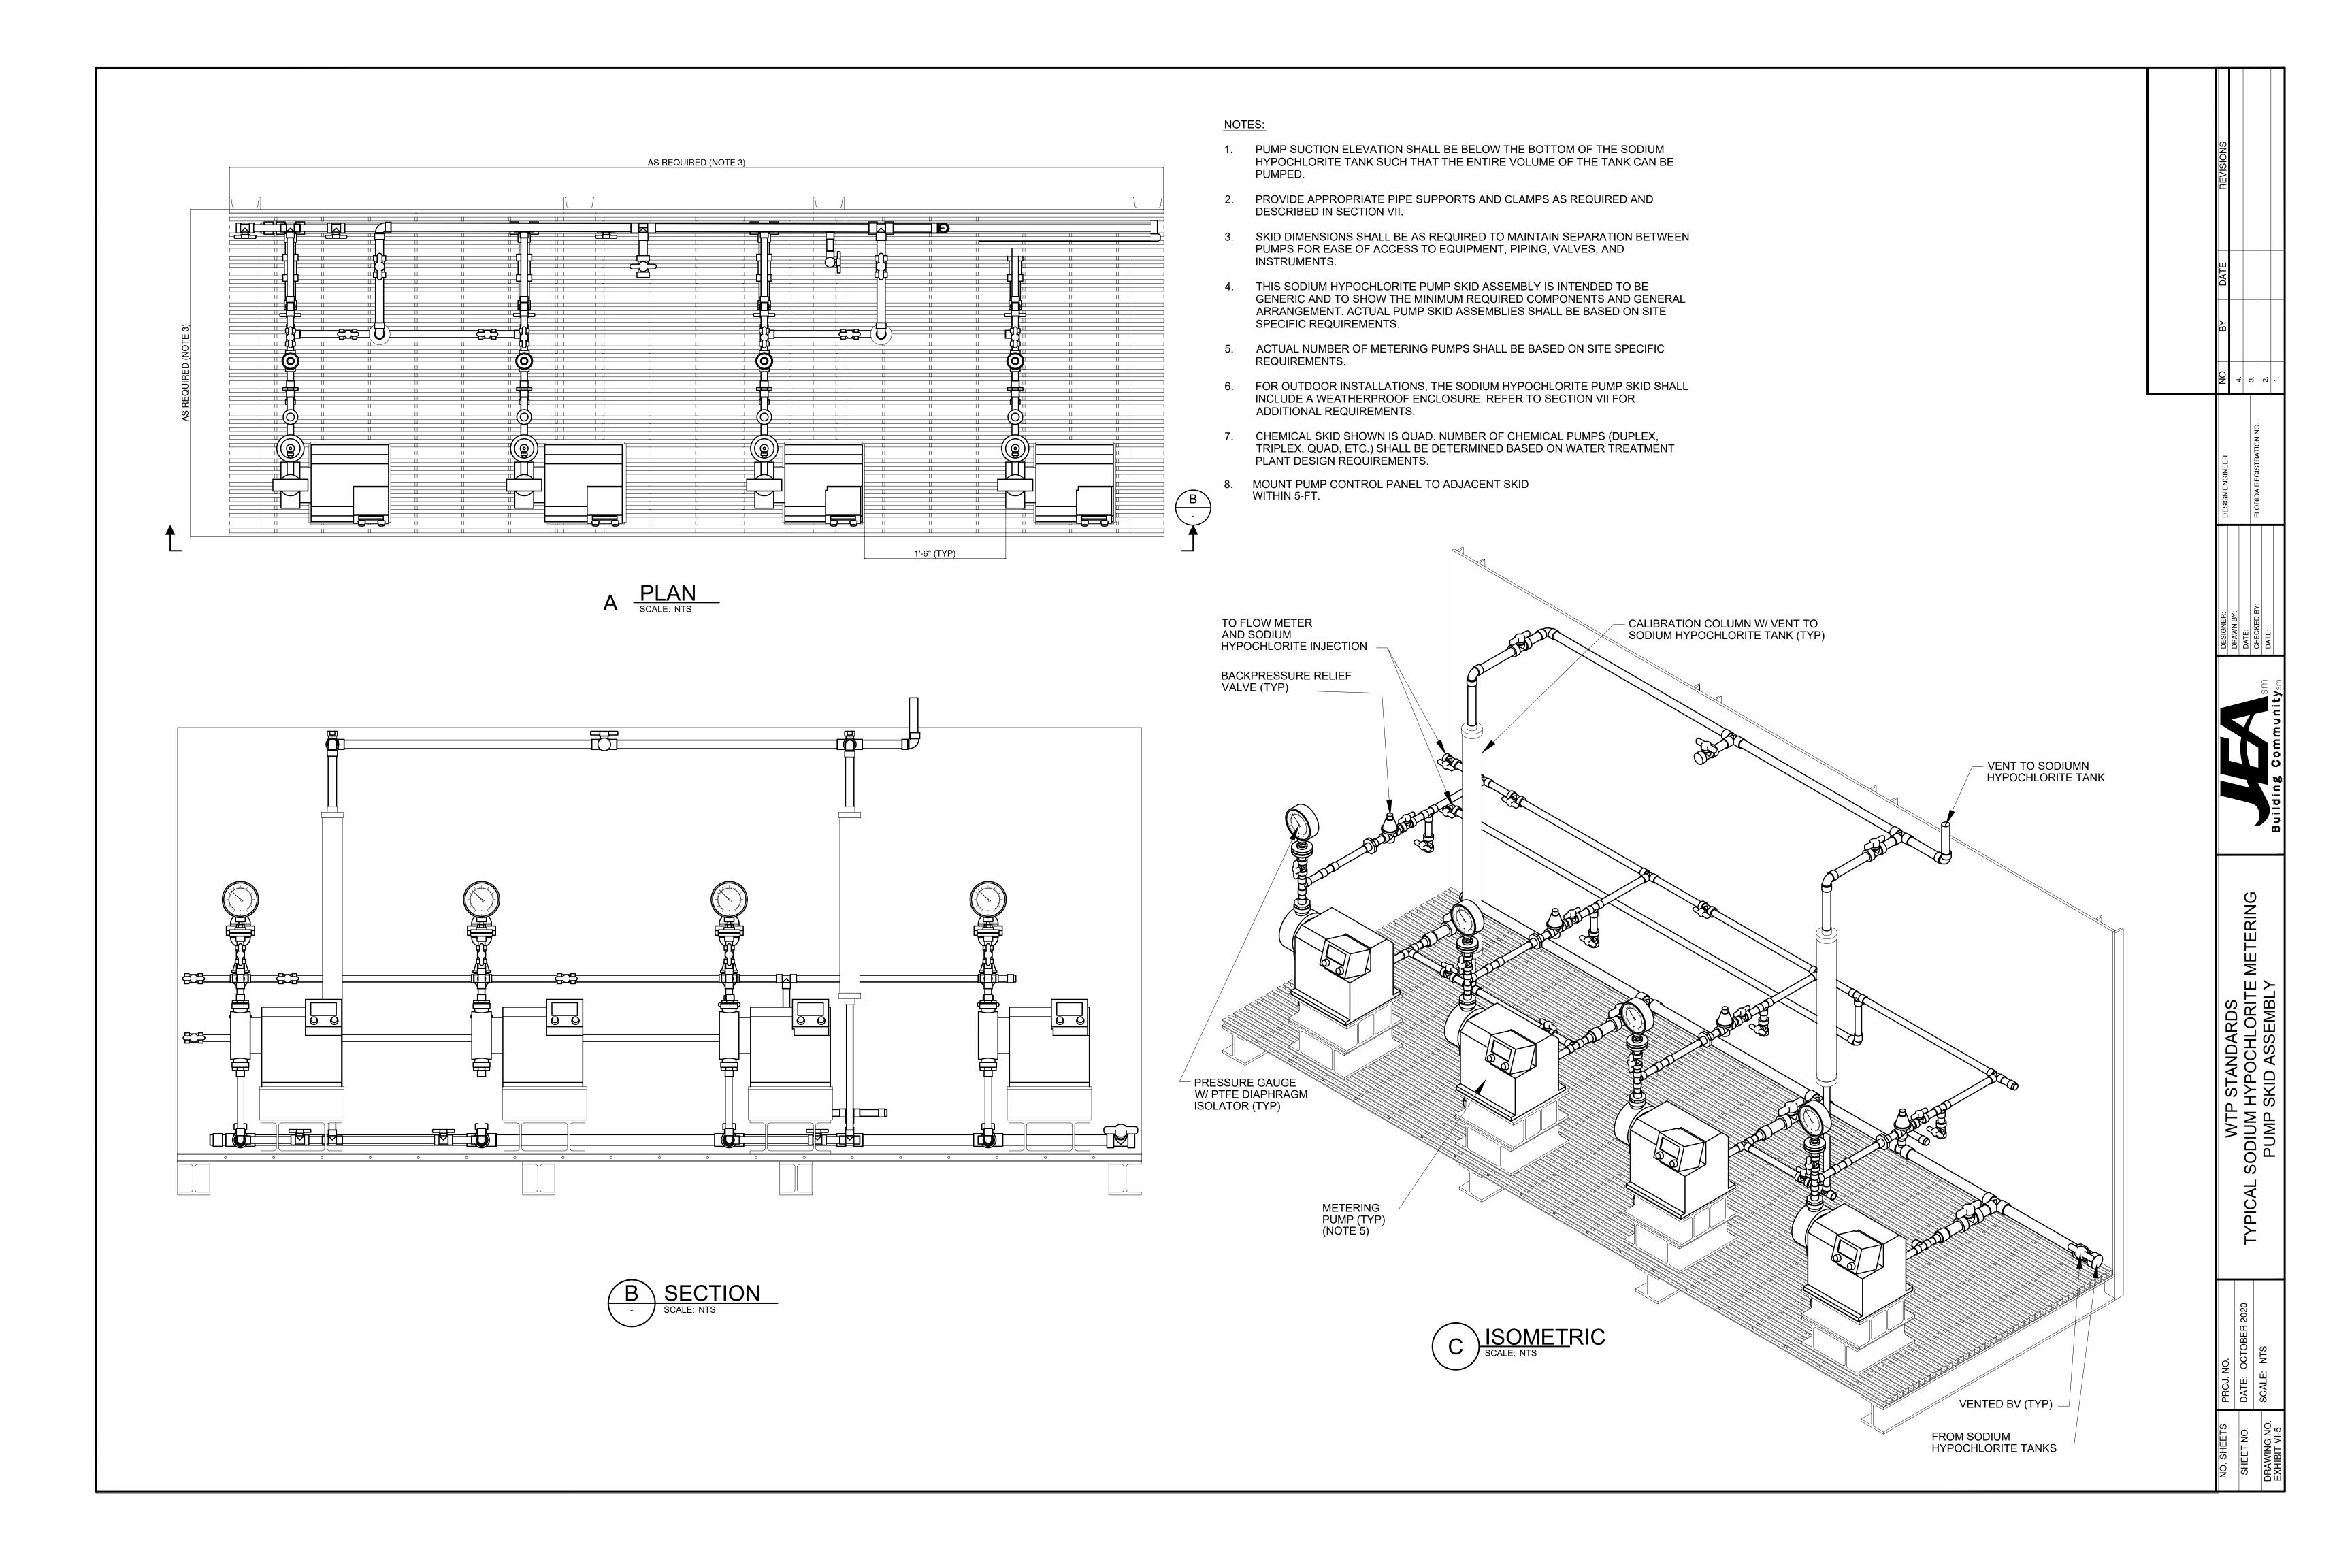


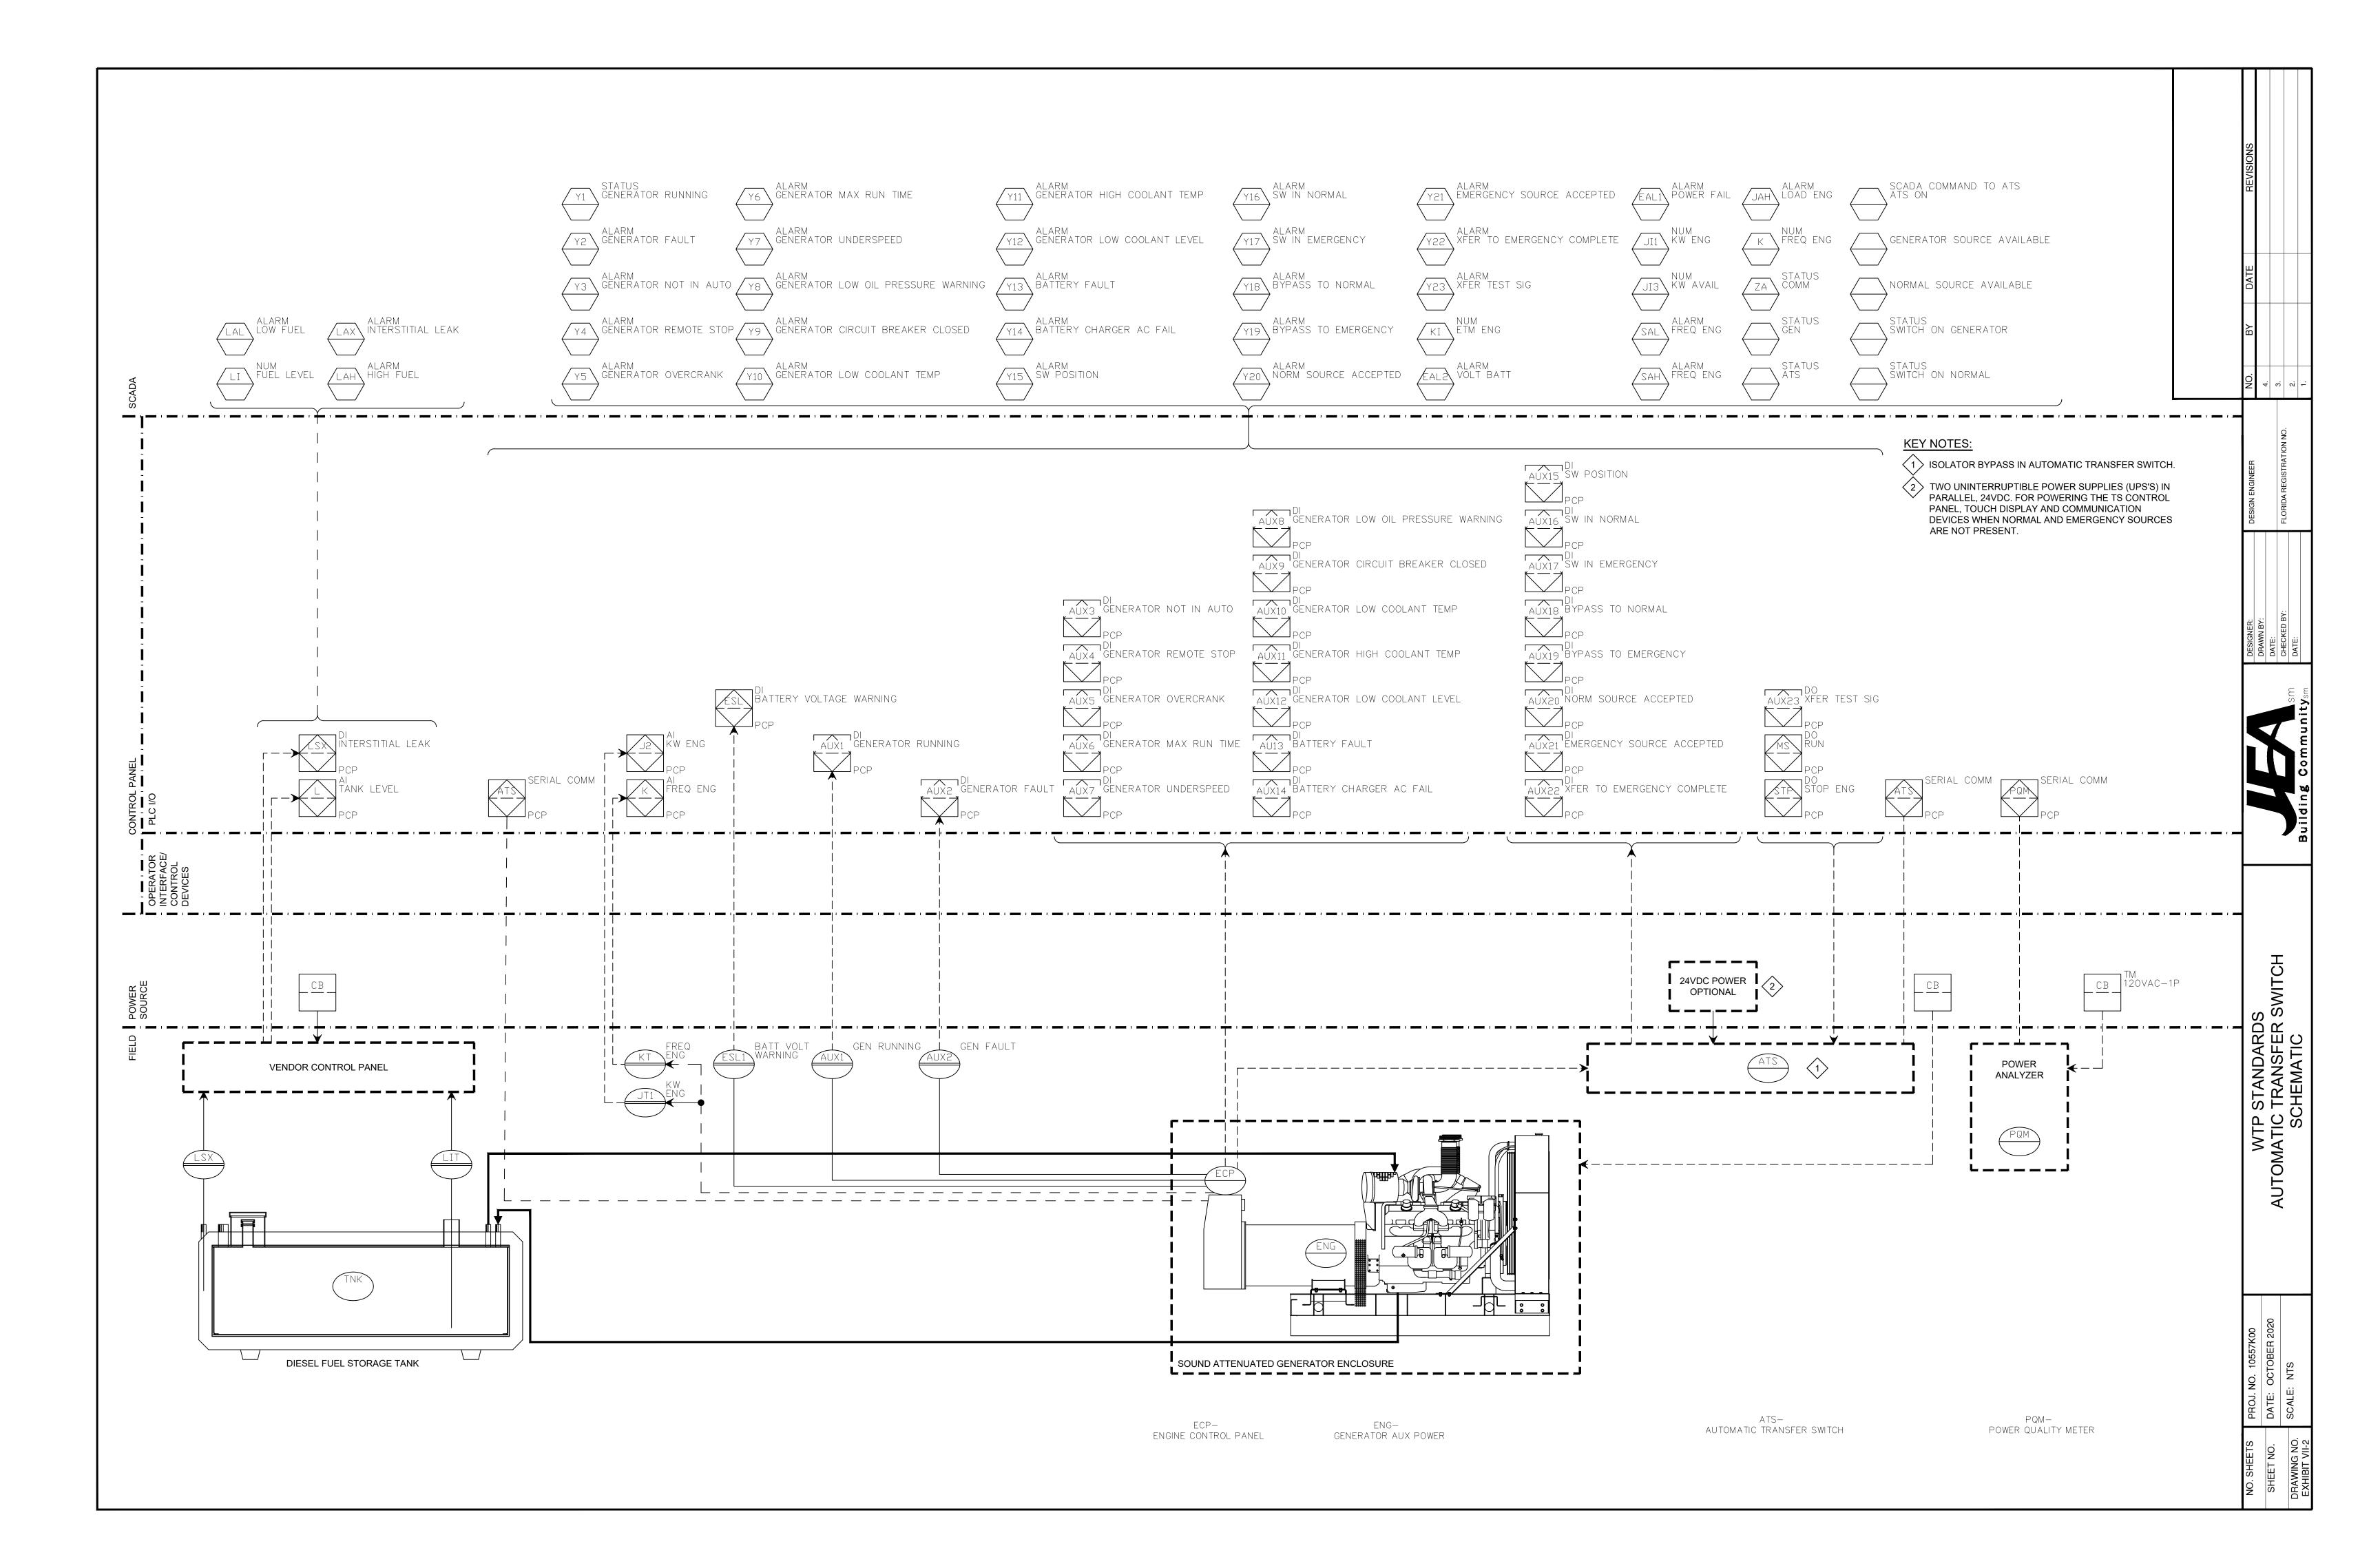


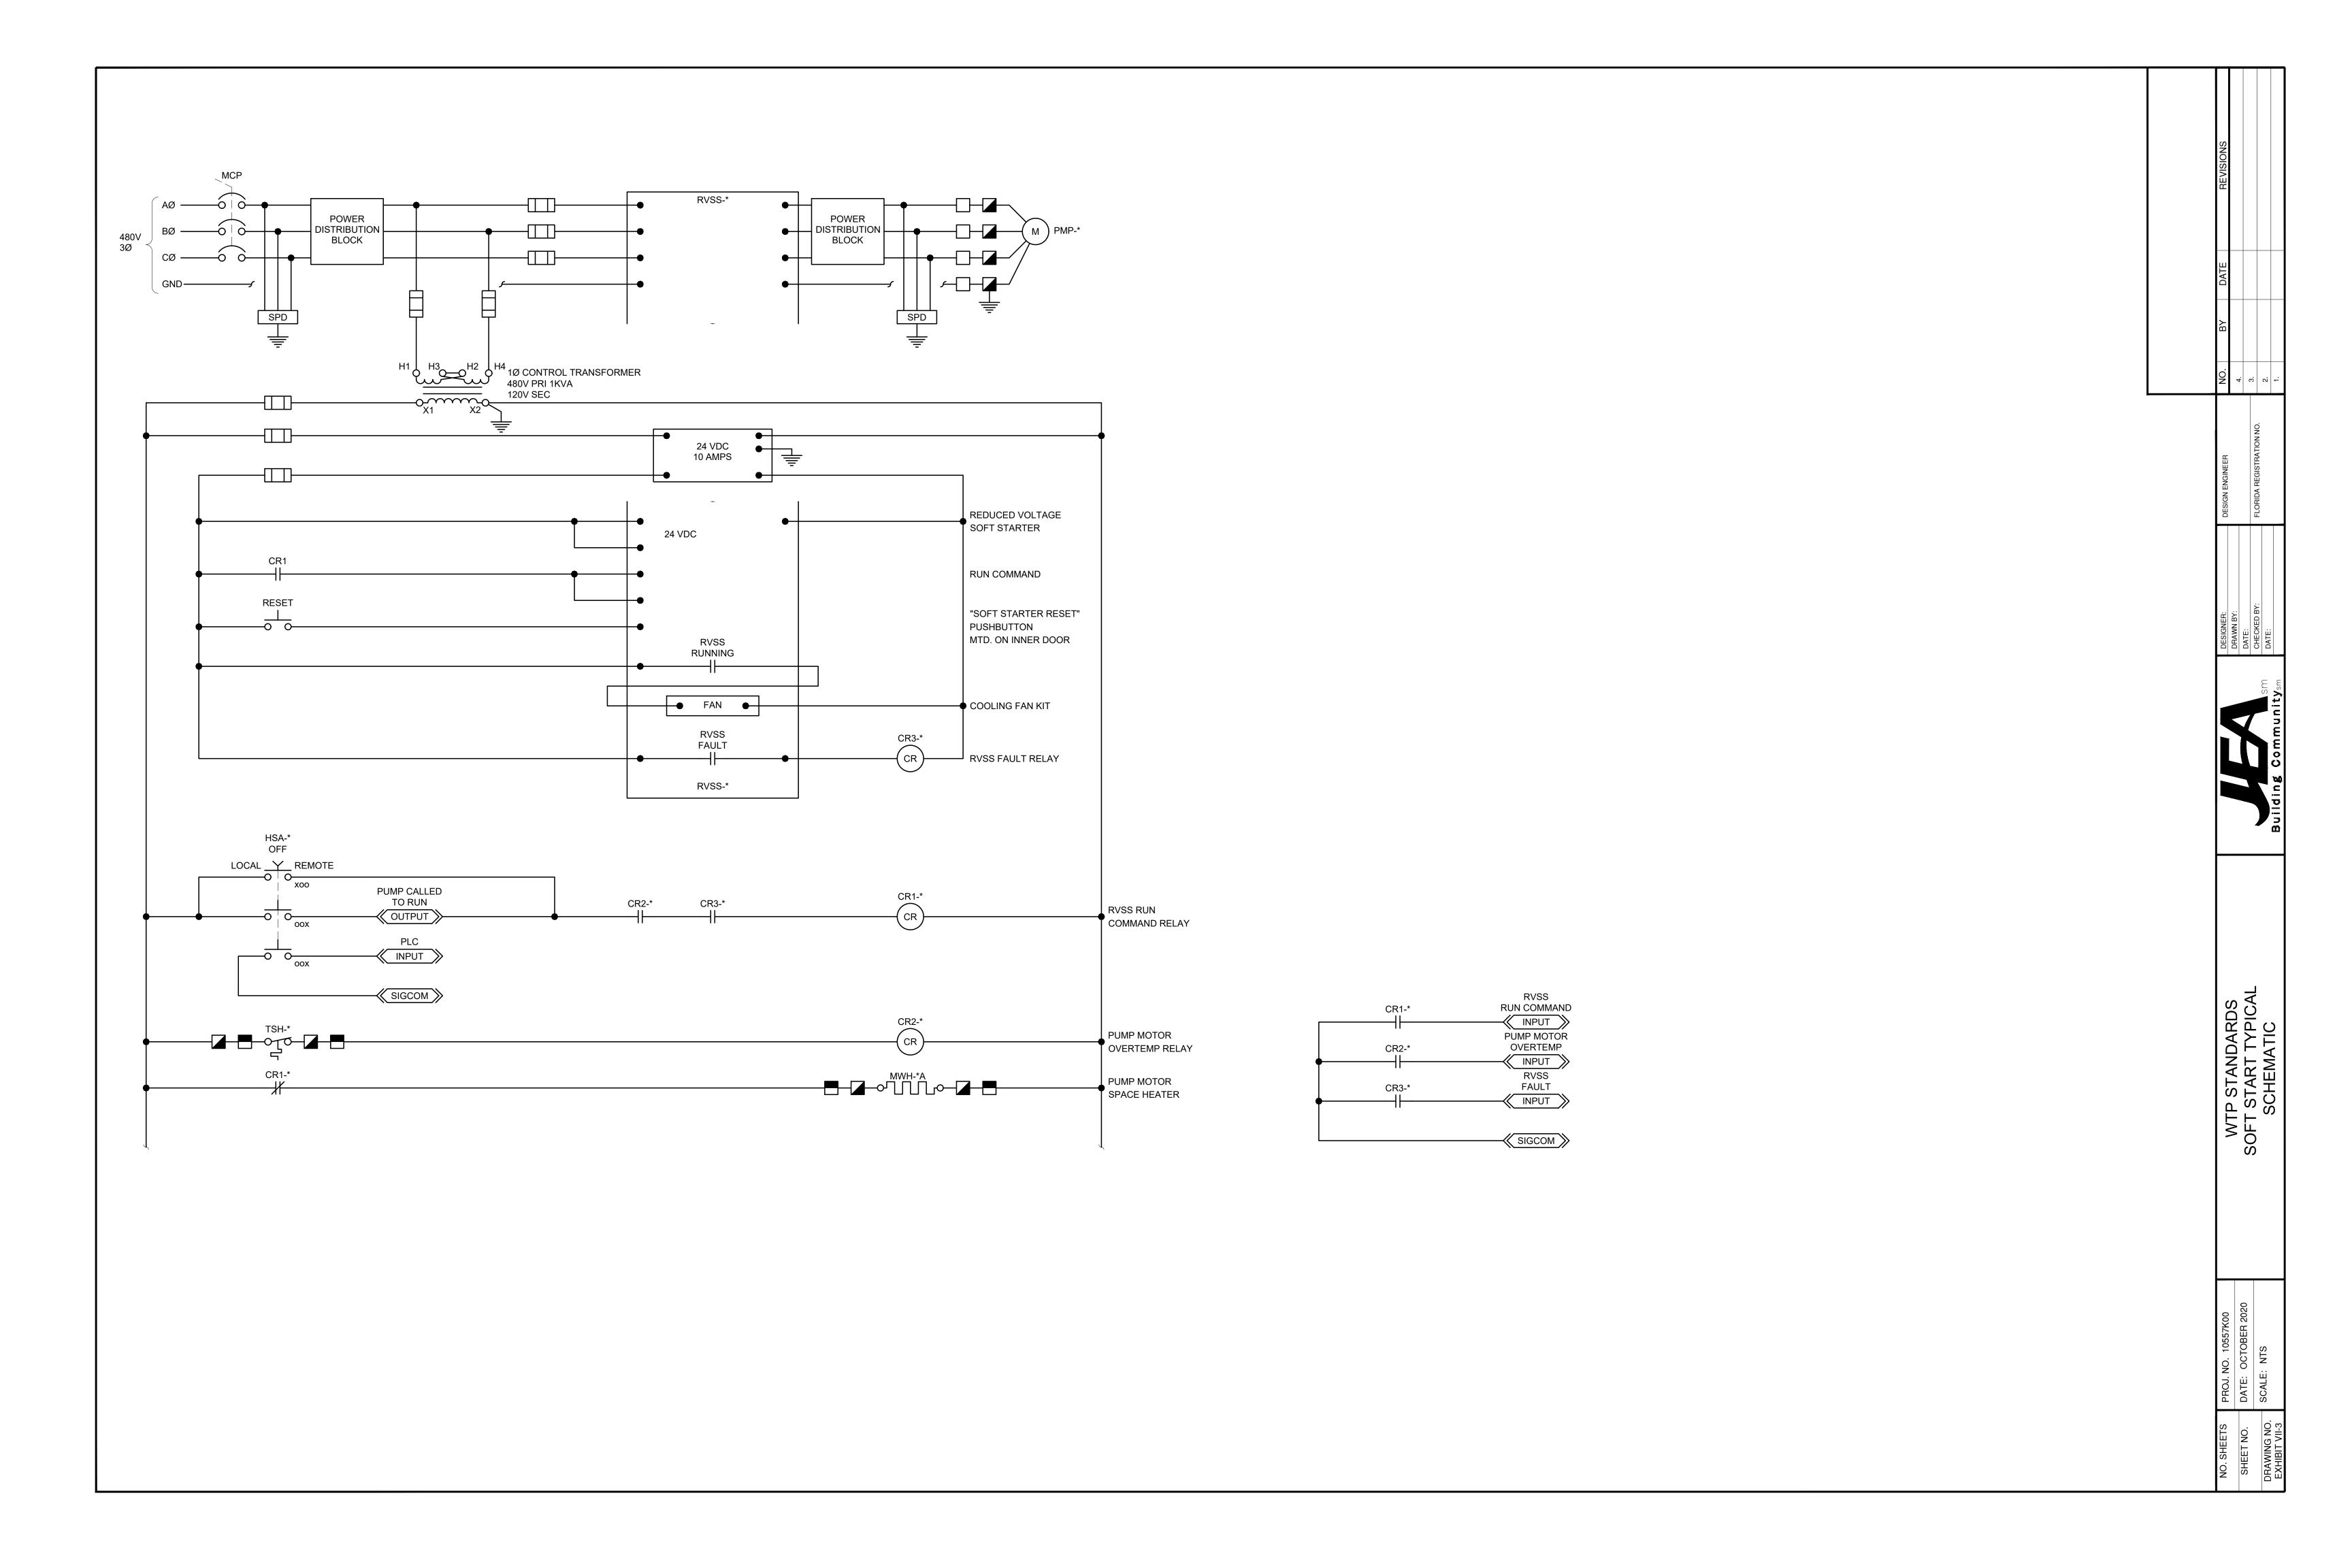

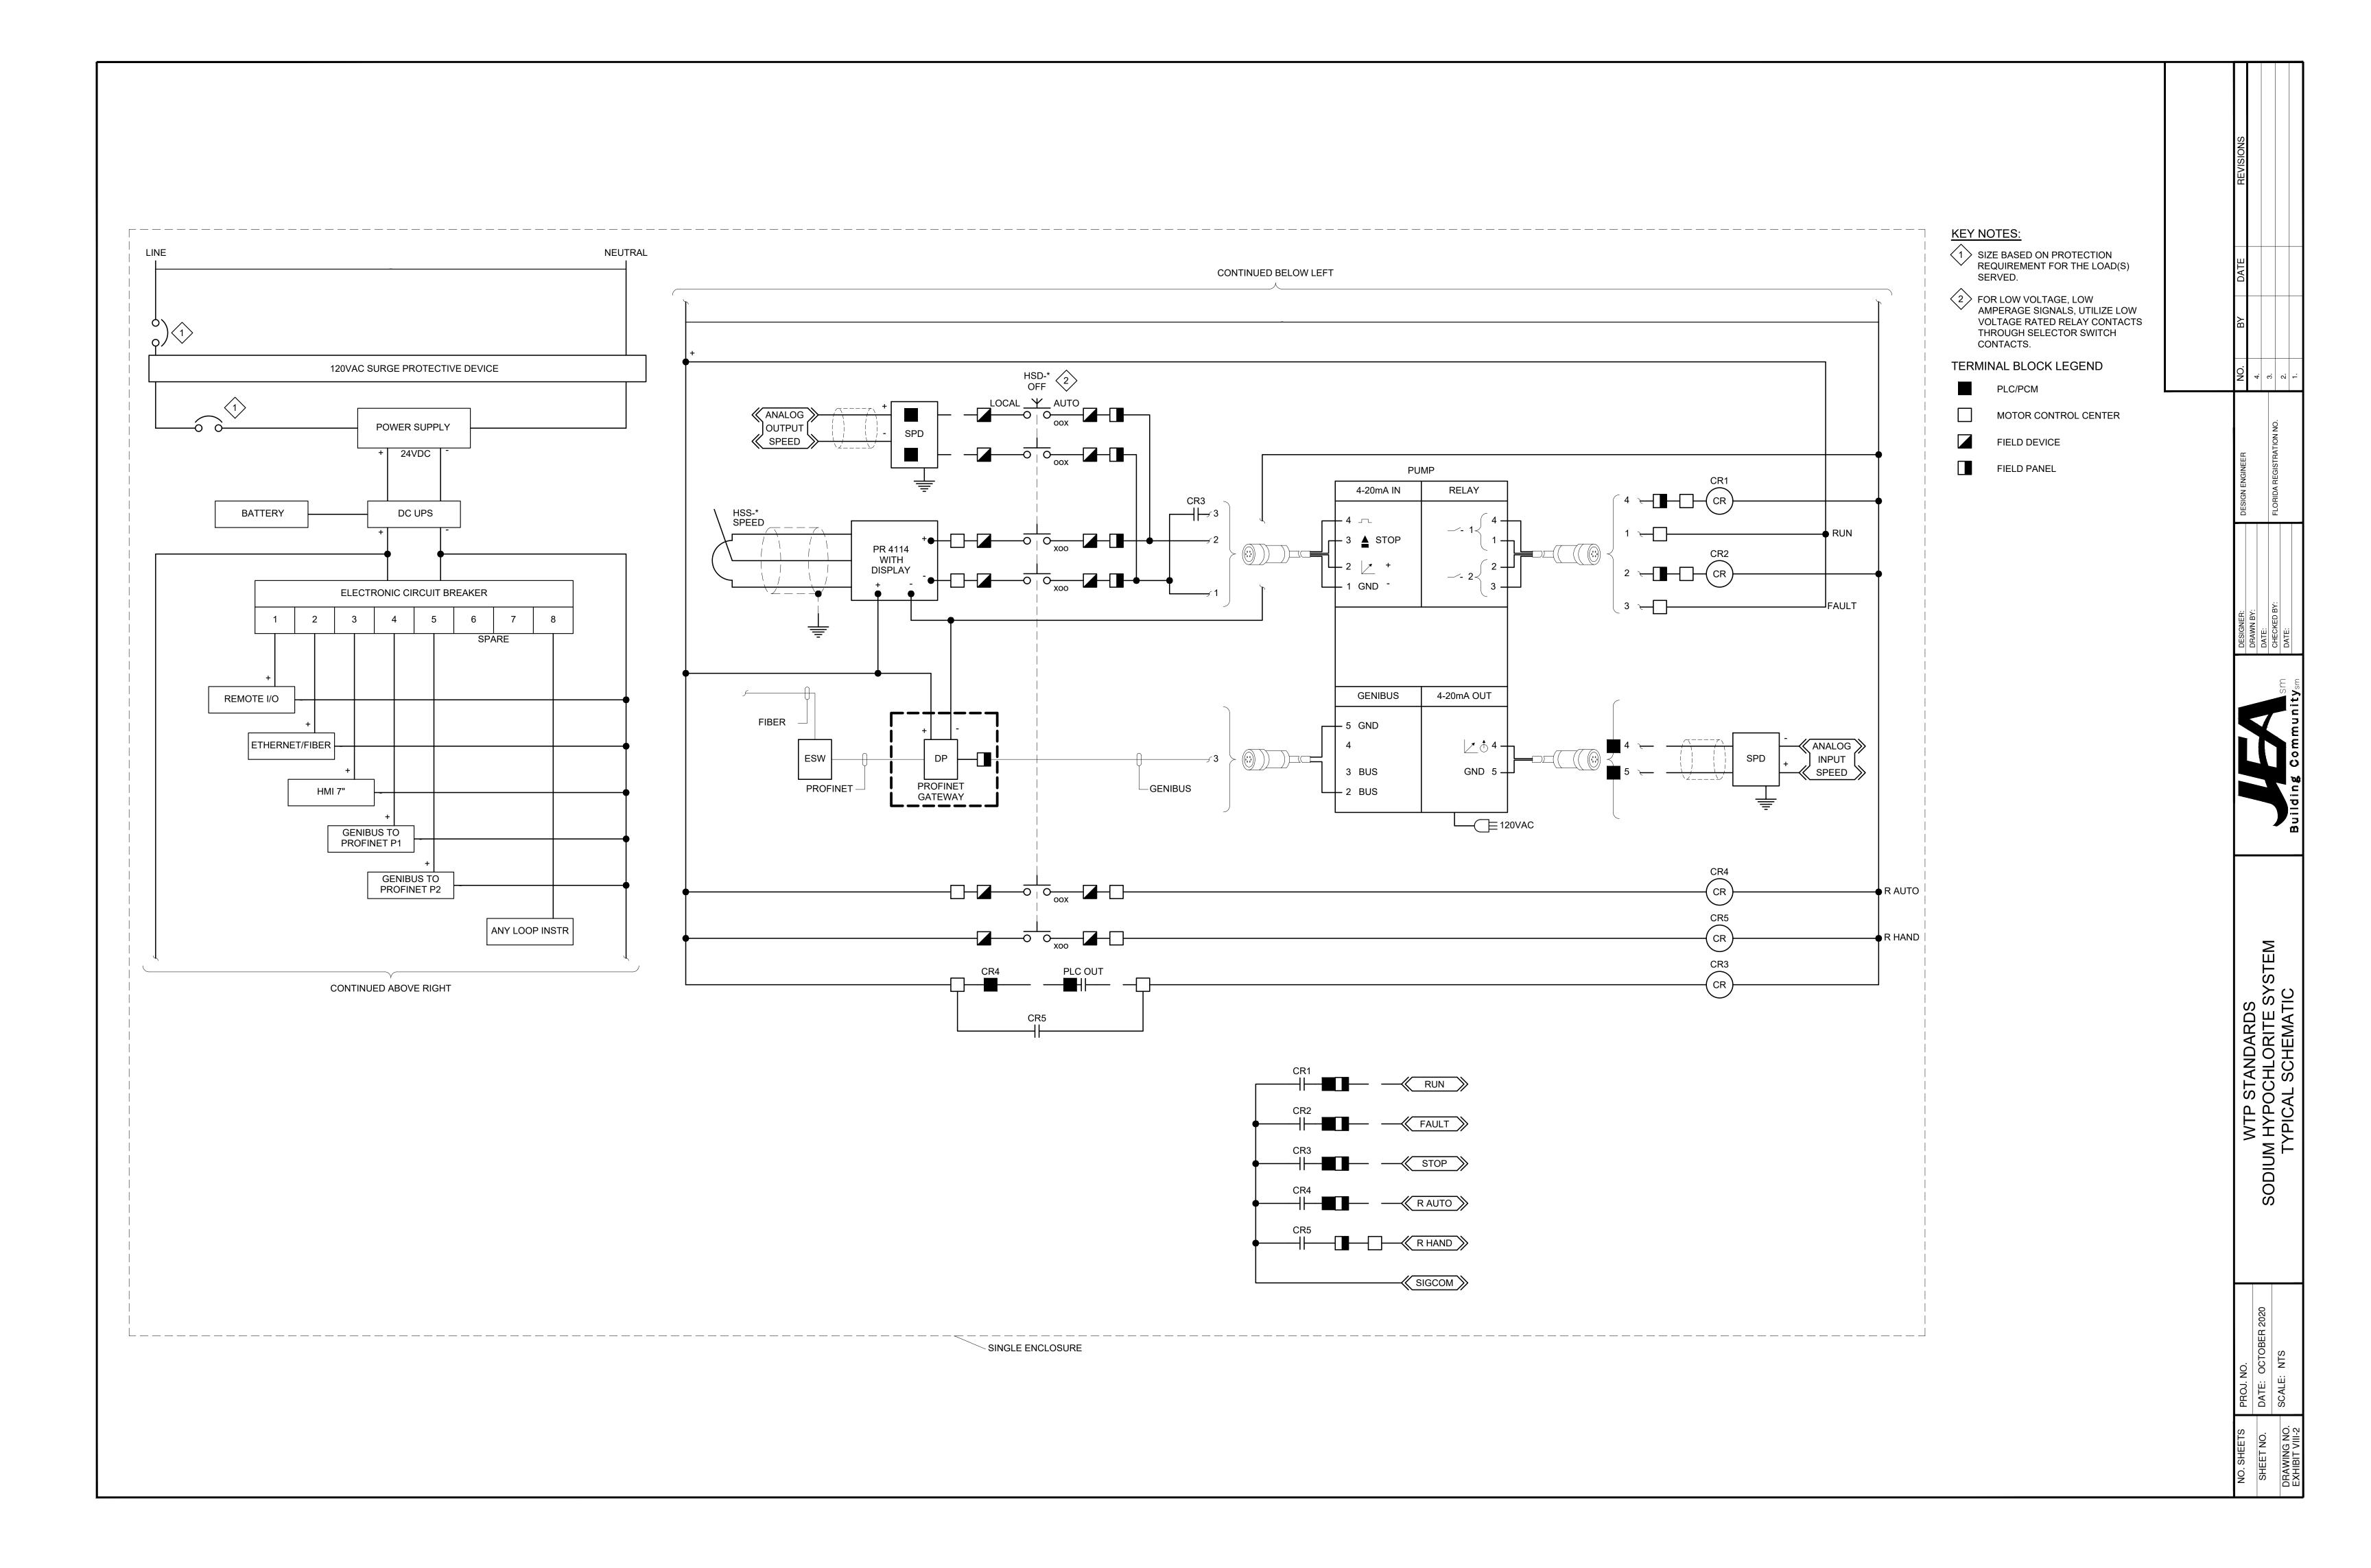

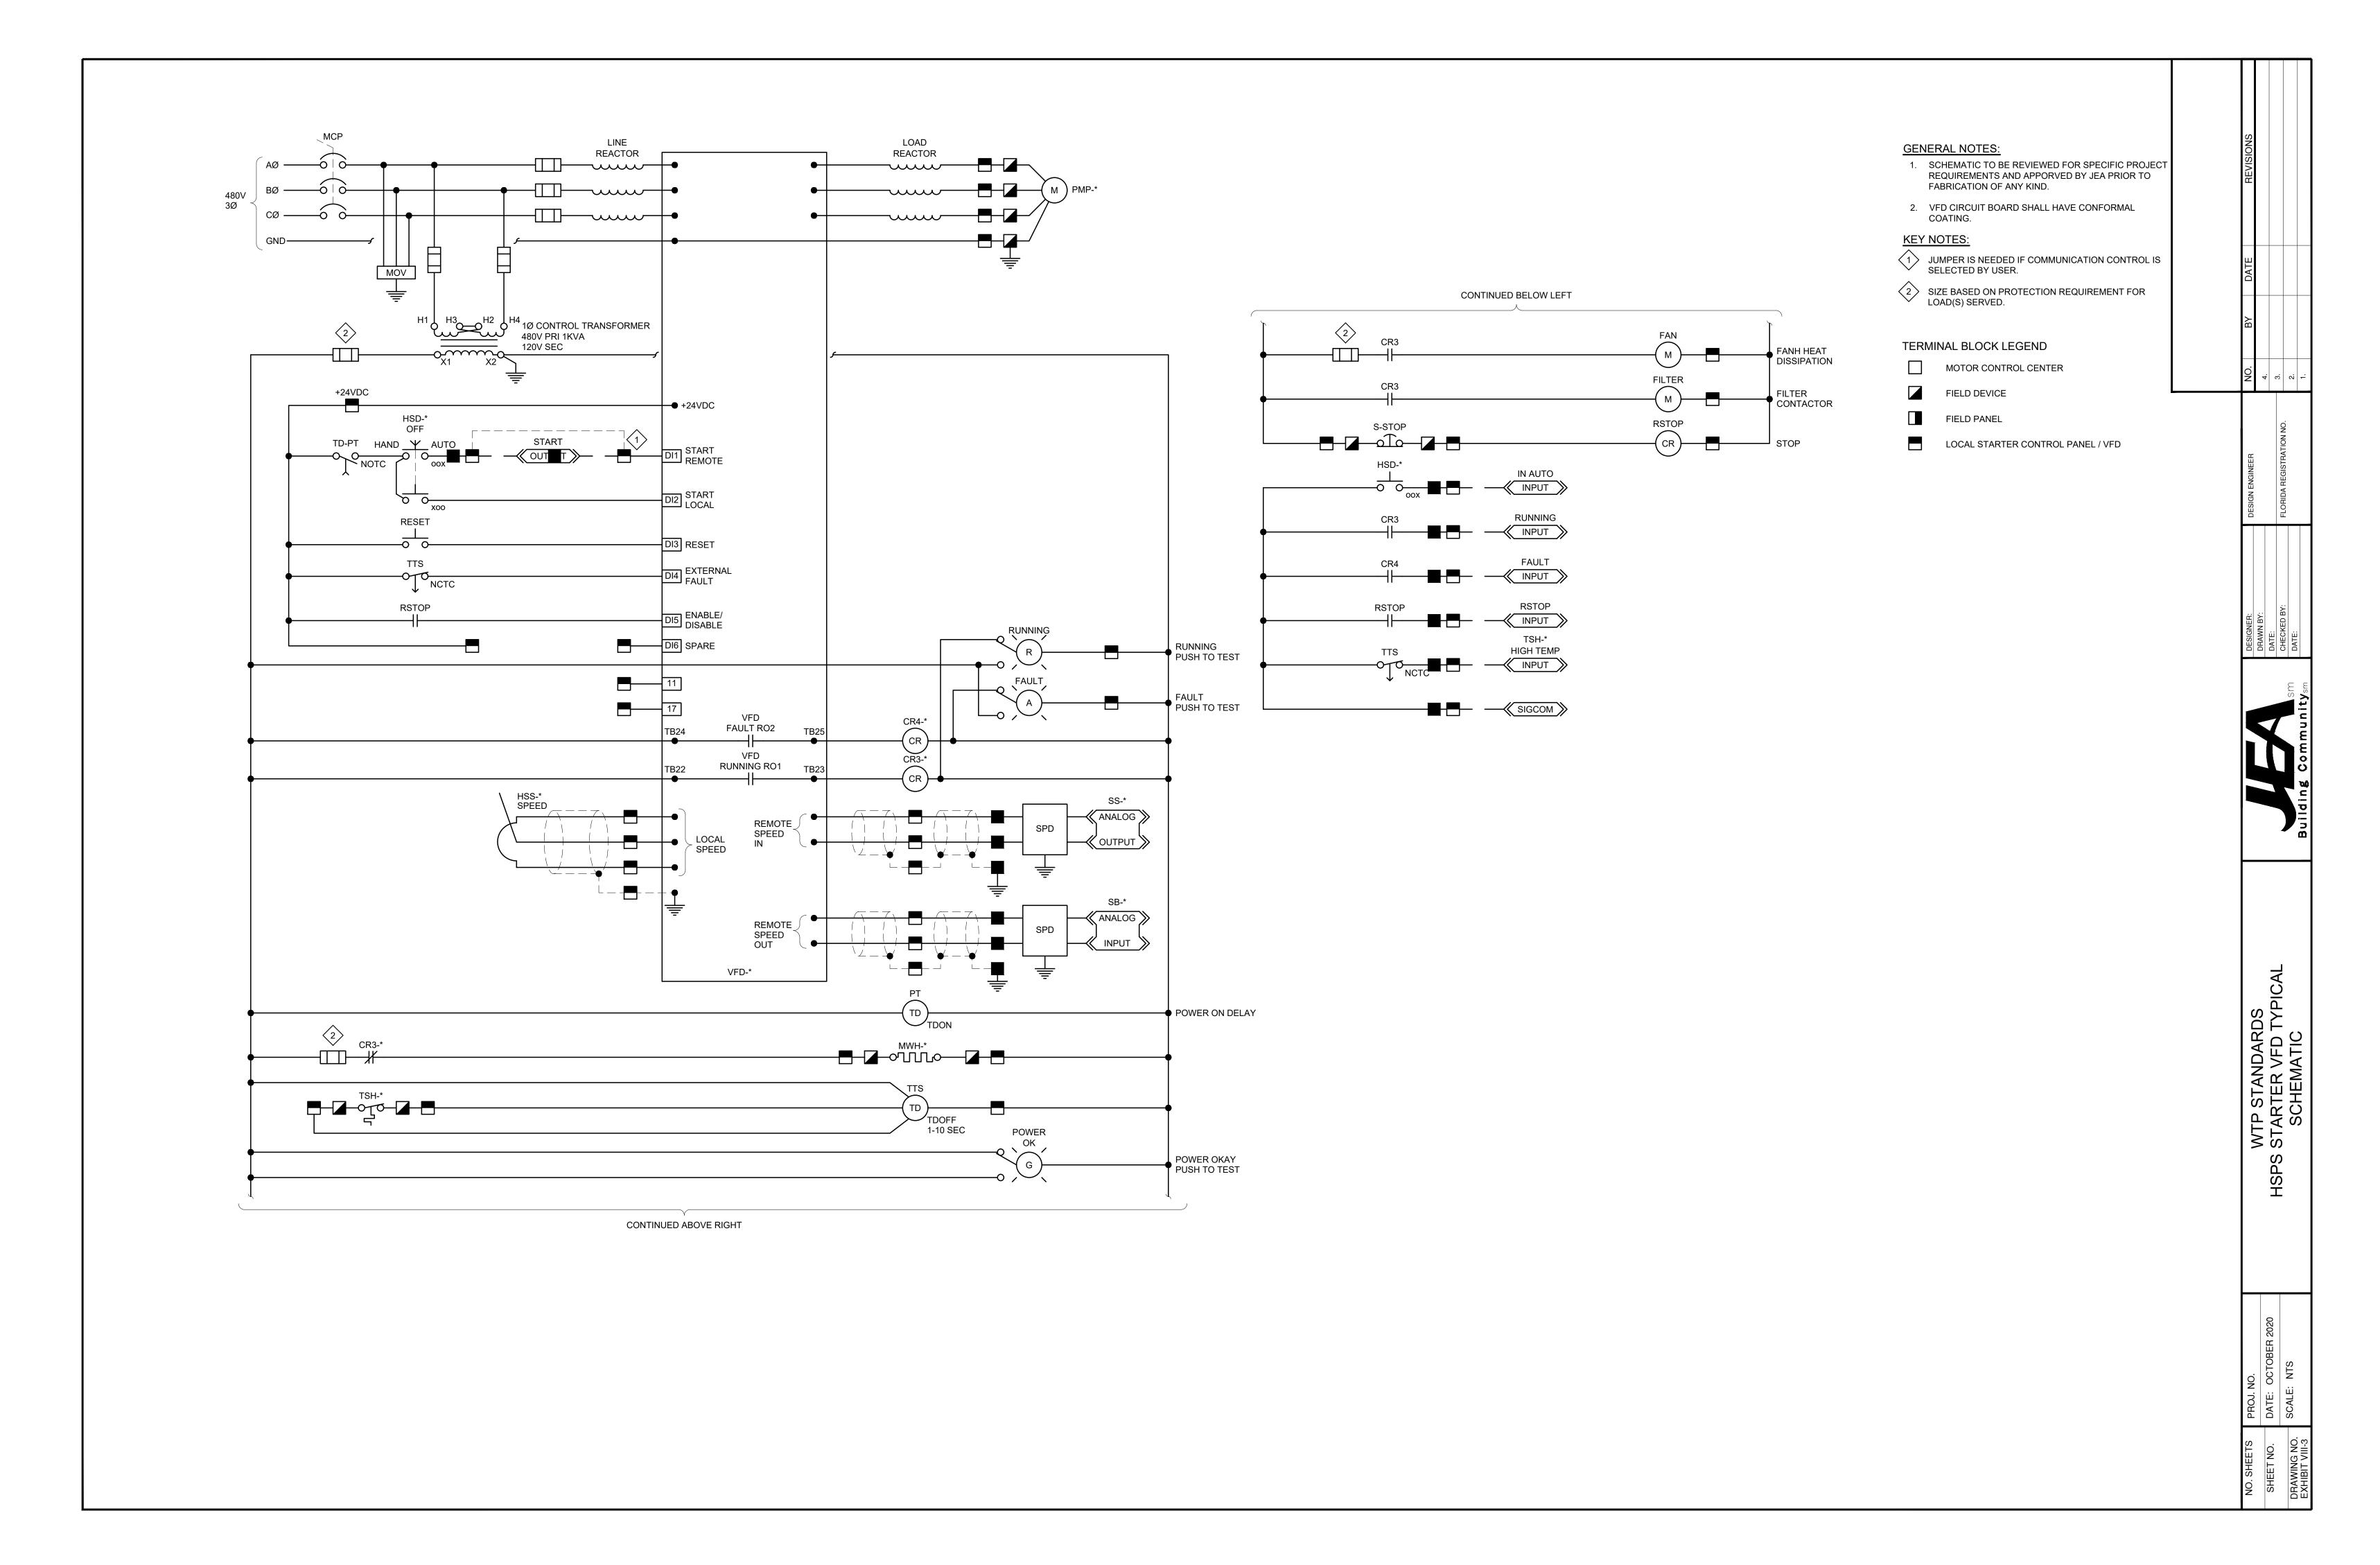

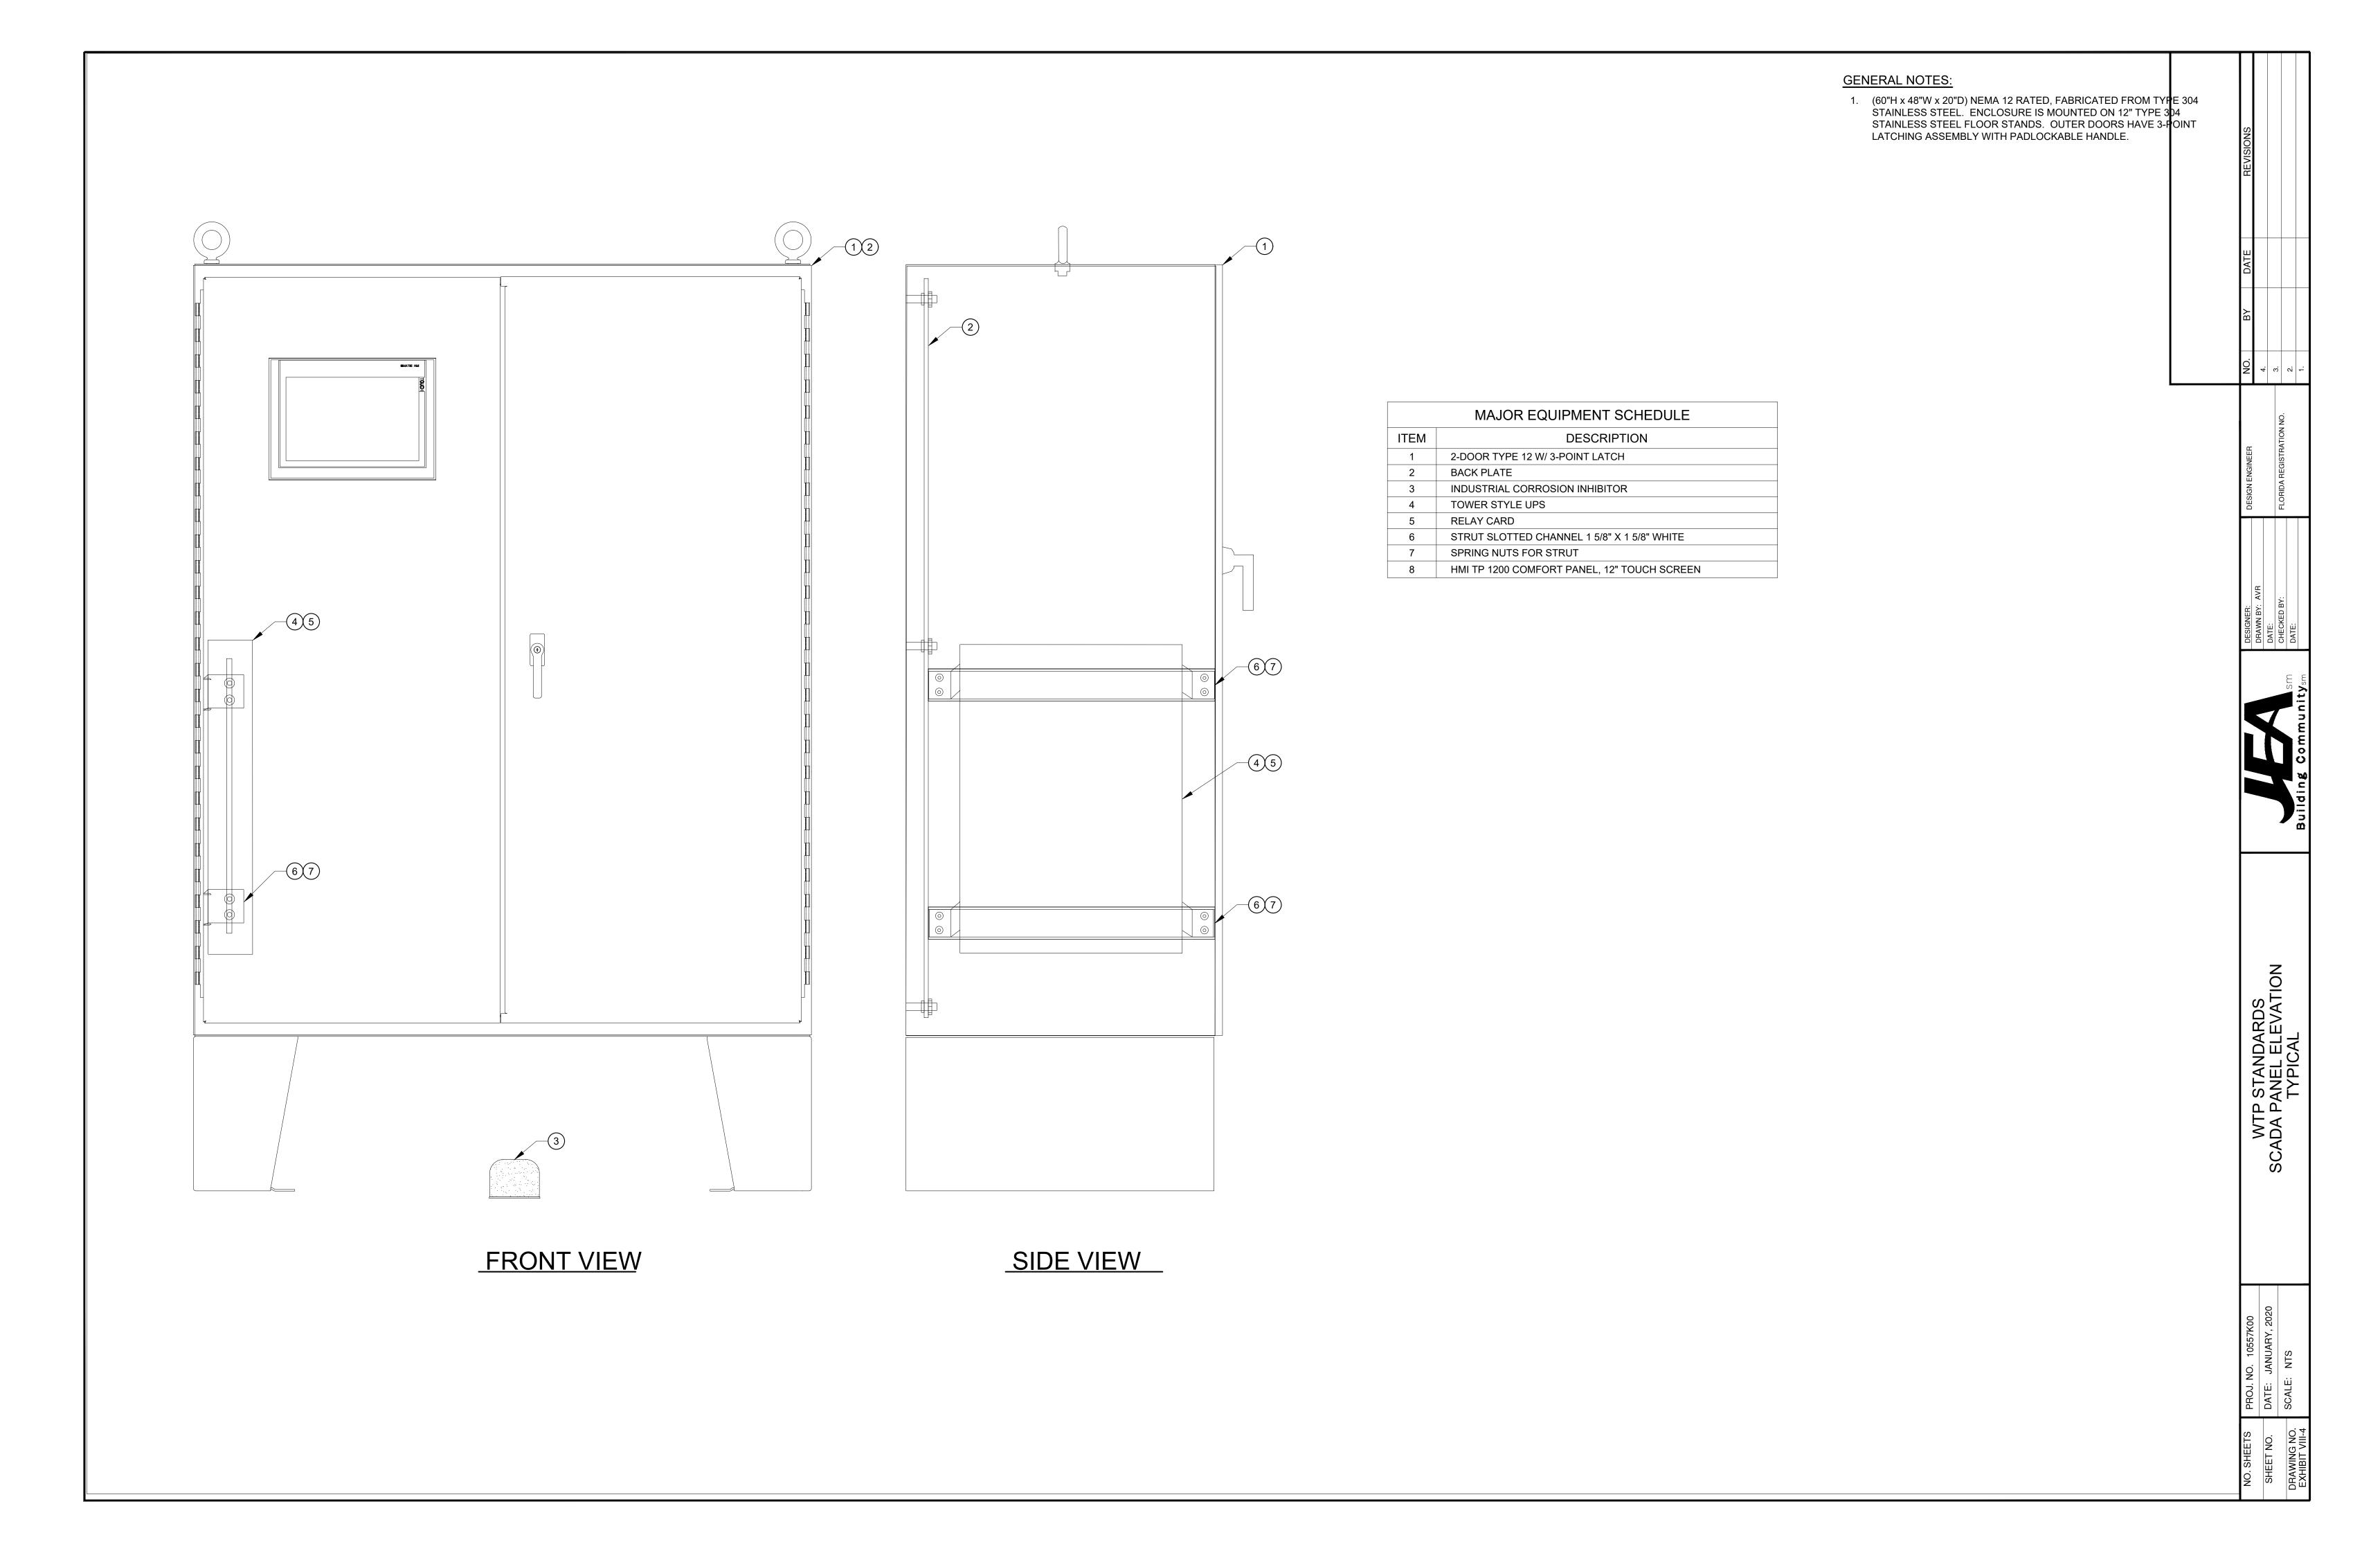

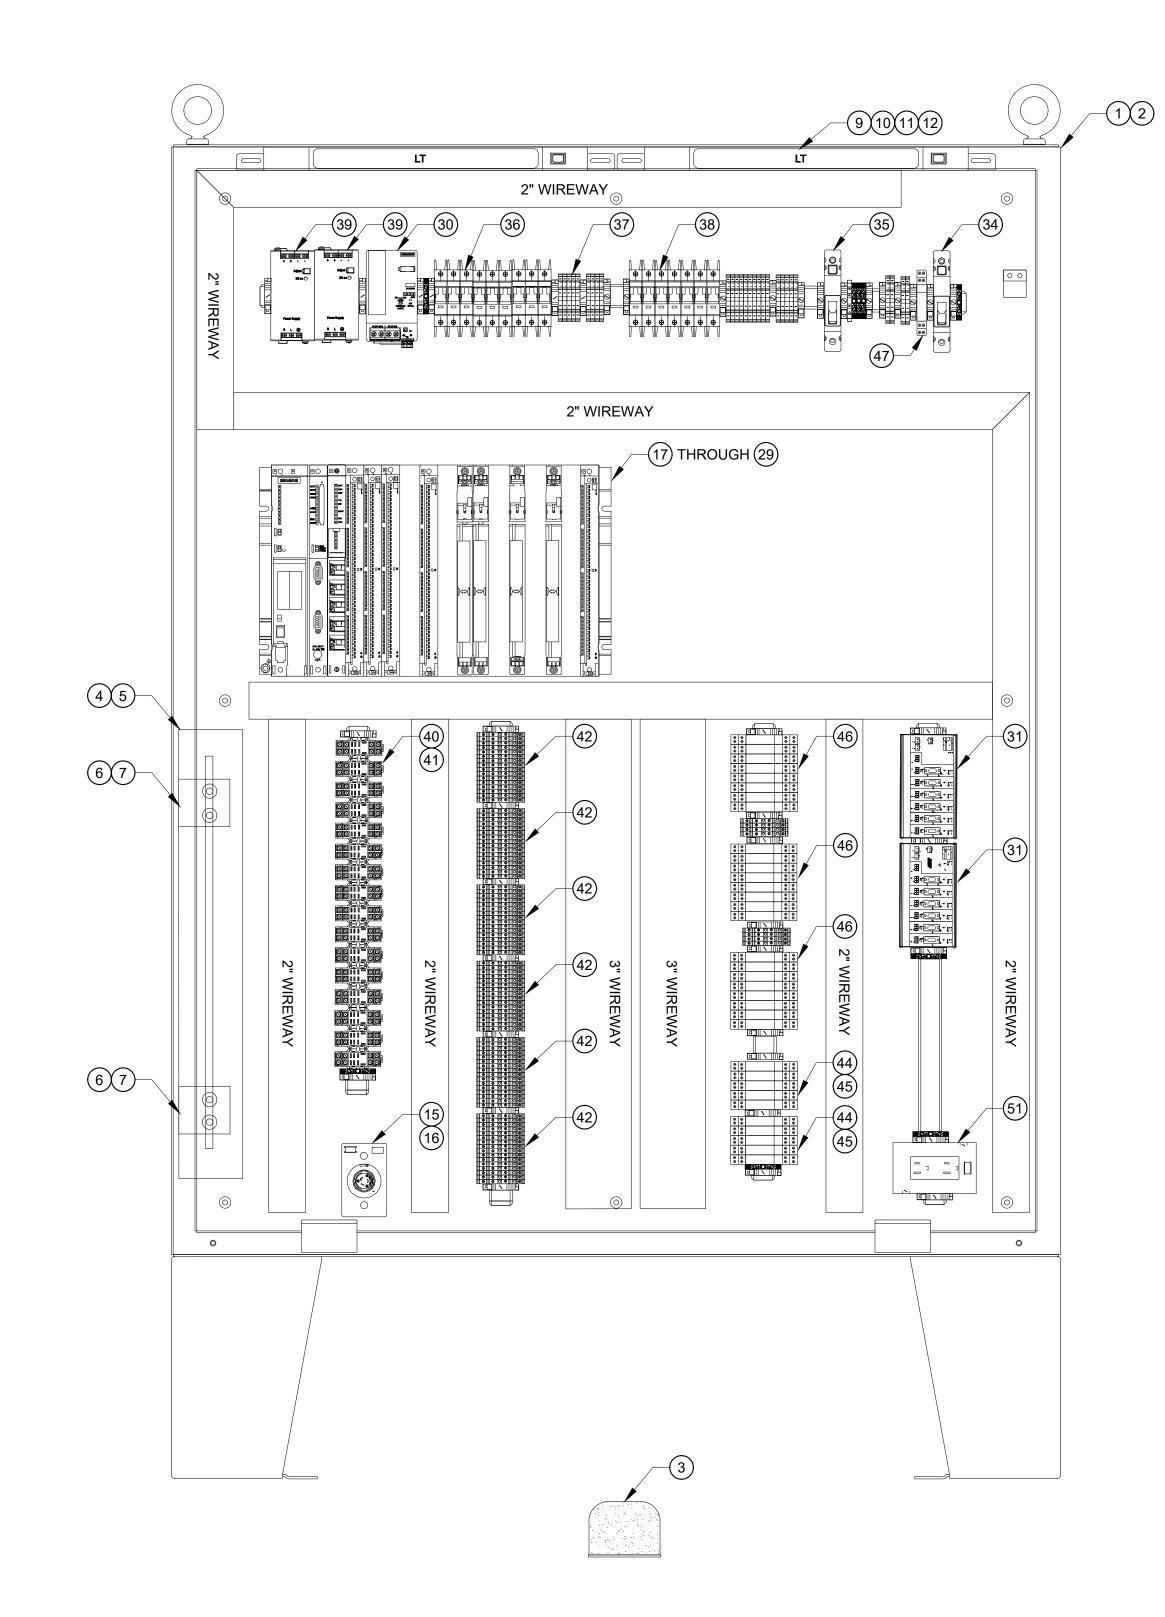

FRONT VIEW

	MAJOR EQUIPMENT SCHEDULE
ITEM	DESCRIPTION
1	2-DOOR W/ 3-POINT LATCH; 60"x48"x24"
2	BACK PLATE
3	INDUSTRIAL CORROSION INHIBITOR
4	TOWER STYLE UPS
5	RELAY CARD
6 7	STRUT SLOTTED CHANNEL 1 5/8"x1 5/8" WHITE SPRING NUTS FOR STRUT
8	HMI TP 1200 COMFORT PANEL, 12" TOUCH SCREEN
9	15" FLUORESCENT FIXTURE
10	FLUORESCENT LAMP
11	FIXTURE POWER CABLE W/ LEADS
12	FIXTURE GANGING CABLE
13	NEMA L5-20 TWIST-LOCK MALE PLUG
14	POWER CORD
15	L5-20 TWIST-LOCK MALE PLUG
16	ELECTRICAL BOX 1-GANG ALUMINIUM
17	SIEMENS PLC
18	POWER SUPPLY
19	BACK-UP BATTERY
20	SIEMENS CPU
21	RAM MEMORY CARD
22	COMMUNICATION PROCESSOR
23	DIGITAL INPUT
24	DIGITAL INPUT
25	DIGITAL OUTPUT
26	ANALOG INPUT
27	ANALOG OUTPUT
28	FRONT CONNECTOR FOR SIGNAL MODULES
29	BLANK MODULE COVERS FOR RACK
30	REDUNDANT DC POWER SUPPLY MODULE
31	PROFIBUS HUB
32	PROFIBUS CONNECTOR W/ DIAGNOSTICS LED'S 45° ANGLE
33	PROFIBUS CONNECTOR W/ DIAGNOSTICS LED'S 90° ANGLE
34	BREAKER
35	BREAKER
36	BRANCH CIRCUIT BREAKER
37	BRANCH CIRCUIT BREAKER
38	BRANCH CIRCUIT BREAKER BRANCH CIRCUIT BREAKER
39	DC POWER SUPPLY
40	RELAY
41	RELAY BASE
42	SURGE PROTECTOR FOR 120VAC SIGNALS
43	SURGE PROTECTOR FOR 24 VDC SIGNALS
44	SURGE PROTECTOR FOR RS-485/PROFIBUS CONNECTIONS
45	SURGE PROTECTOR BASE
46	SURGE PROTECTOR FOR 24V 4-20 MA SIGNALS
47	SURGE PROTECTOR FOR 120V SIGNALS
48	TERMINAL 1 CIRCUIT
49	GROUNDING TERMINAL GREEN YELLOW
50	TERMINAL END CLAMP
51	GFCI DUPLEX RECEPTACLE

GENERAL NOTES:

- (60"H x 48"W x 20"D) NEMA 12 RATED, FABRICATED FROM TYPE 304 STAINLESS STEEL. ENCLOSURE IS MOUNTED ON 12" TYPE 304 STAINLESS STEEL FLOOR STANDS. OUTER DOORS HAVE 3-POINT LATCHING ASSEMBLY WITH PADLOCKABLE HANDLE.
- ENCLOSURE BACK PANEL FABRICATED FROM CARBON STEEL WITH INDUSTRIAL GRADE WHITE ENAMEL FINISH.


ESIGN ENGINEER NO. 4.


DRAWN BY: AVR
DATE:
CHECKED BY:
DATE:


Suilding Communitysn


WTP STANDARDS SADA PANEL INTERNAL ELEVATI


DATE: JANUARY, 2020
SCALE: NTS

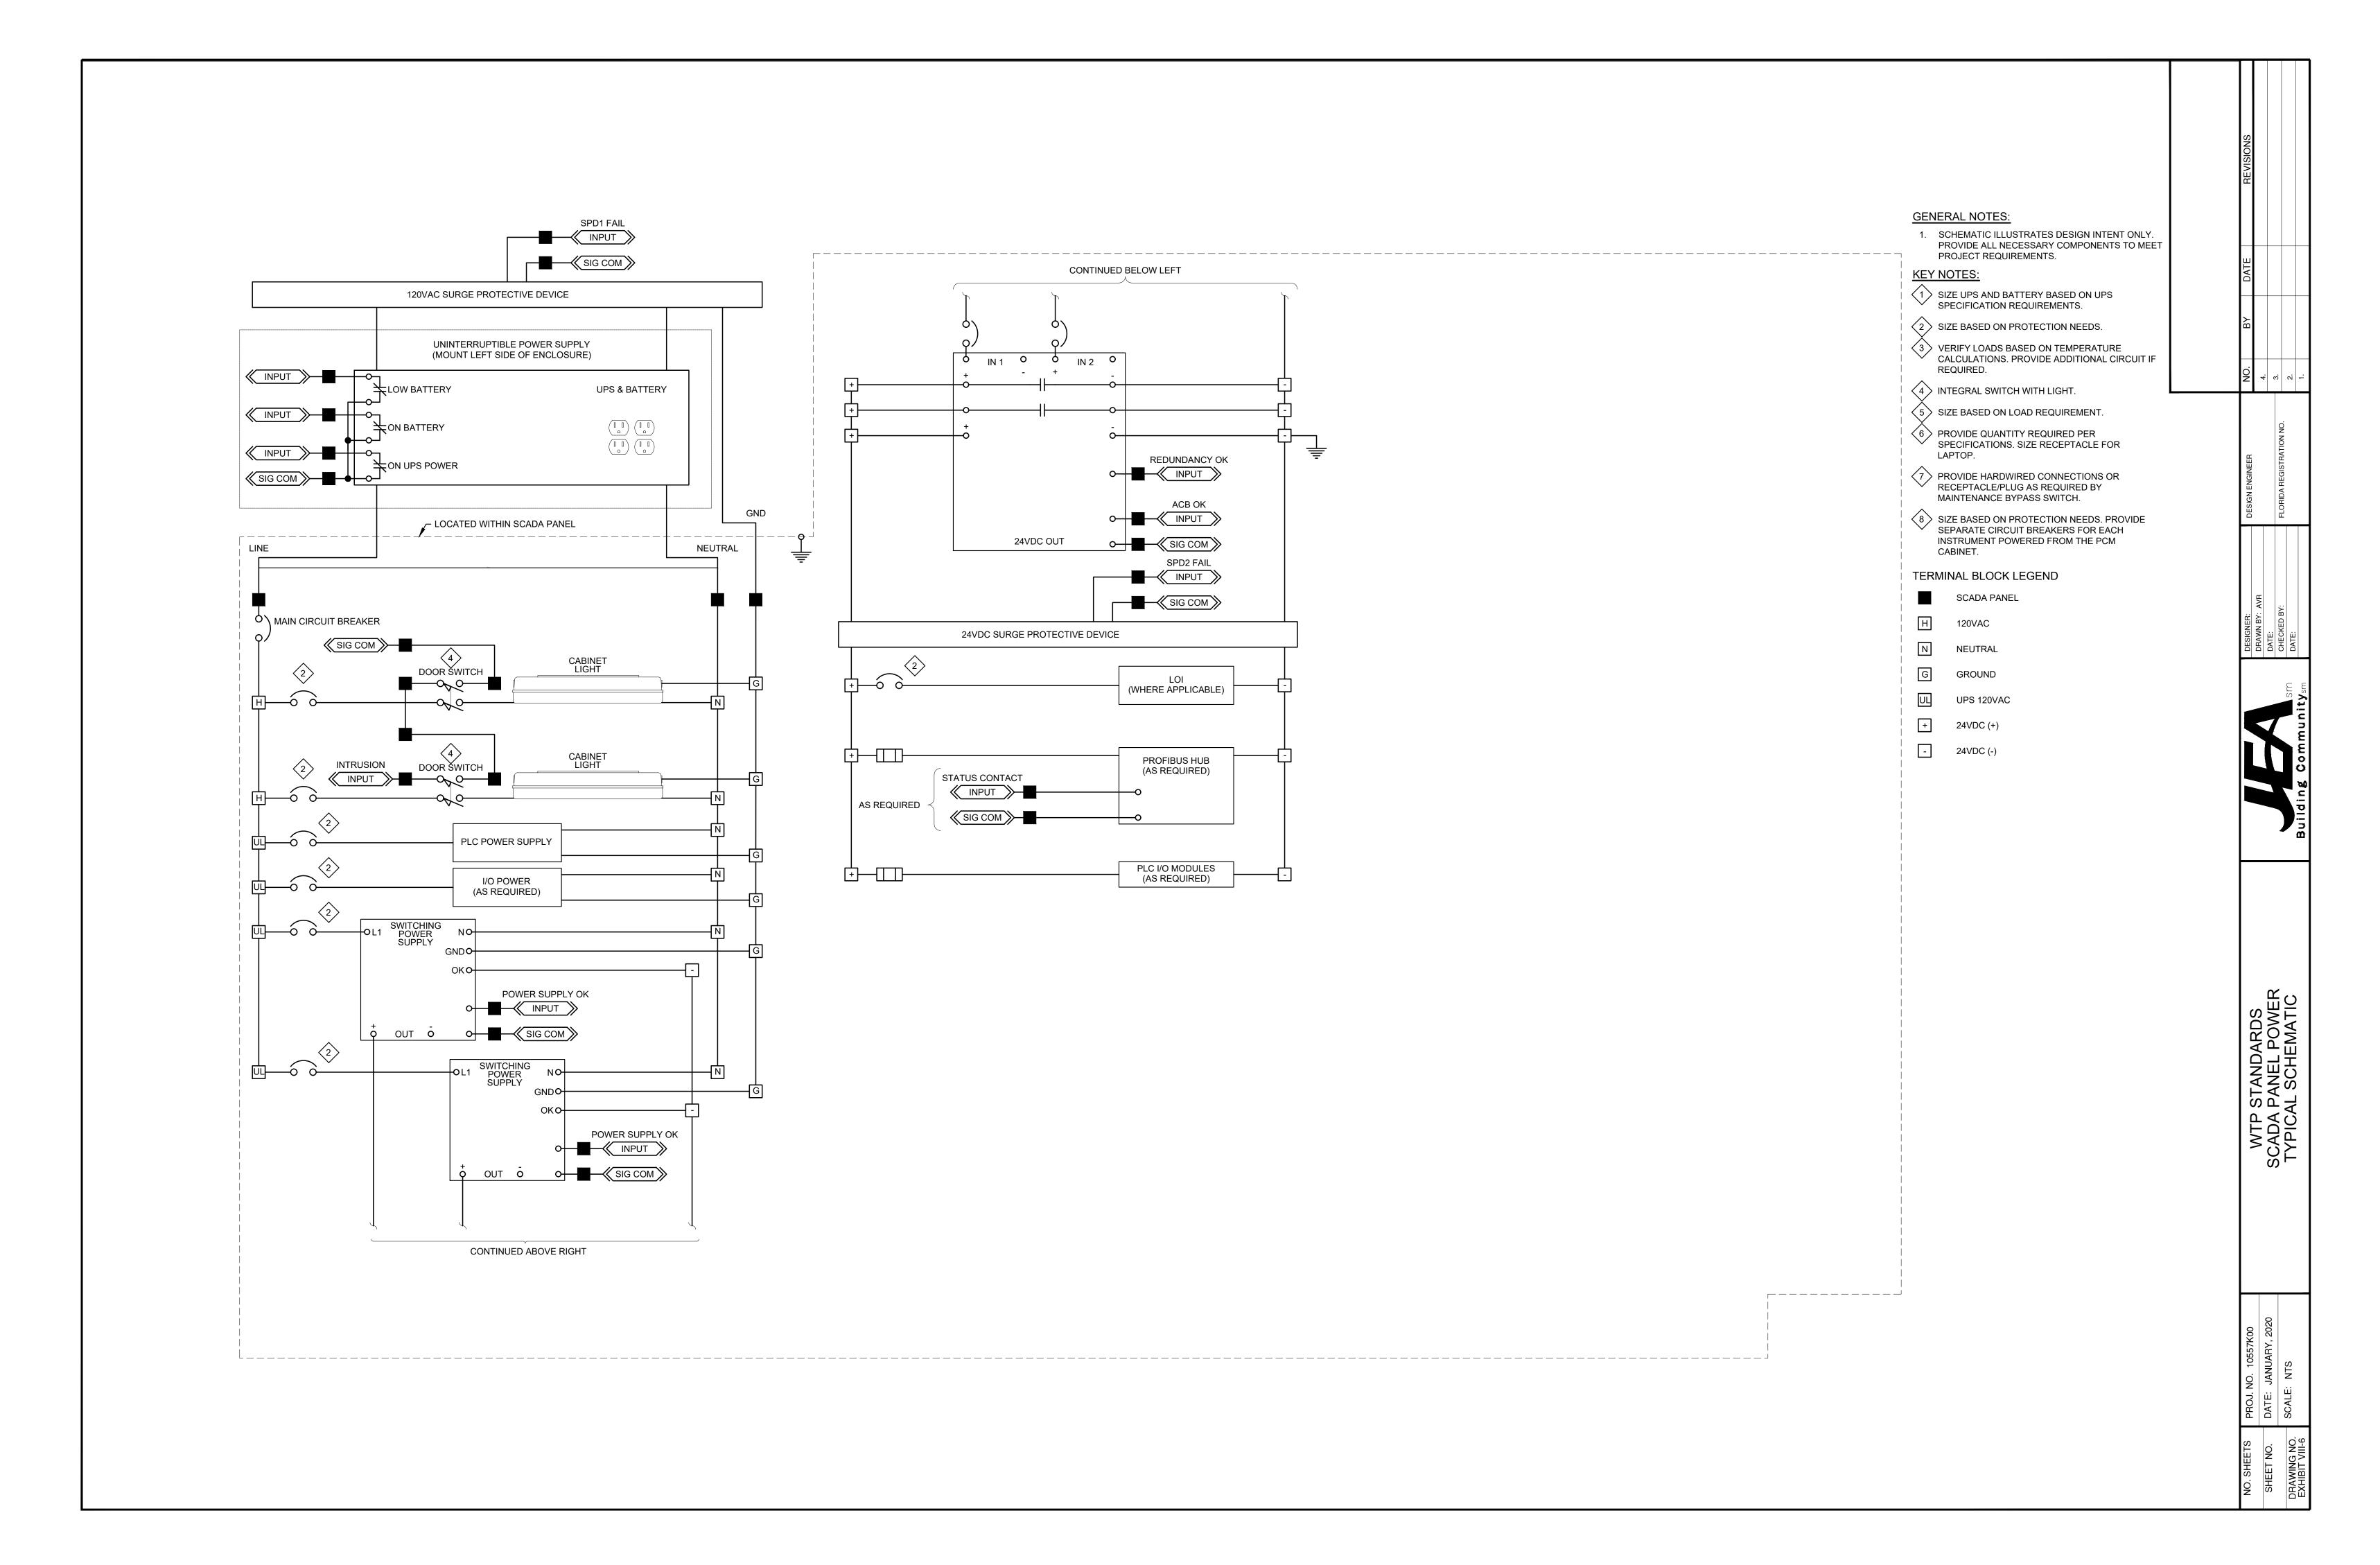


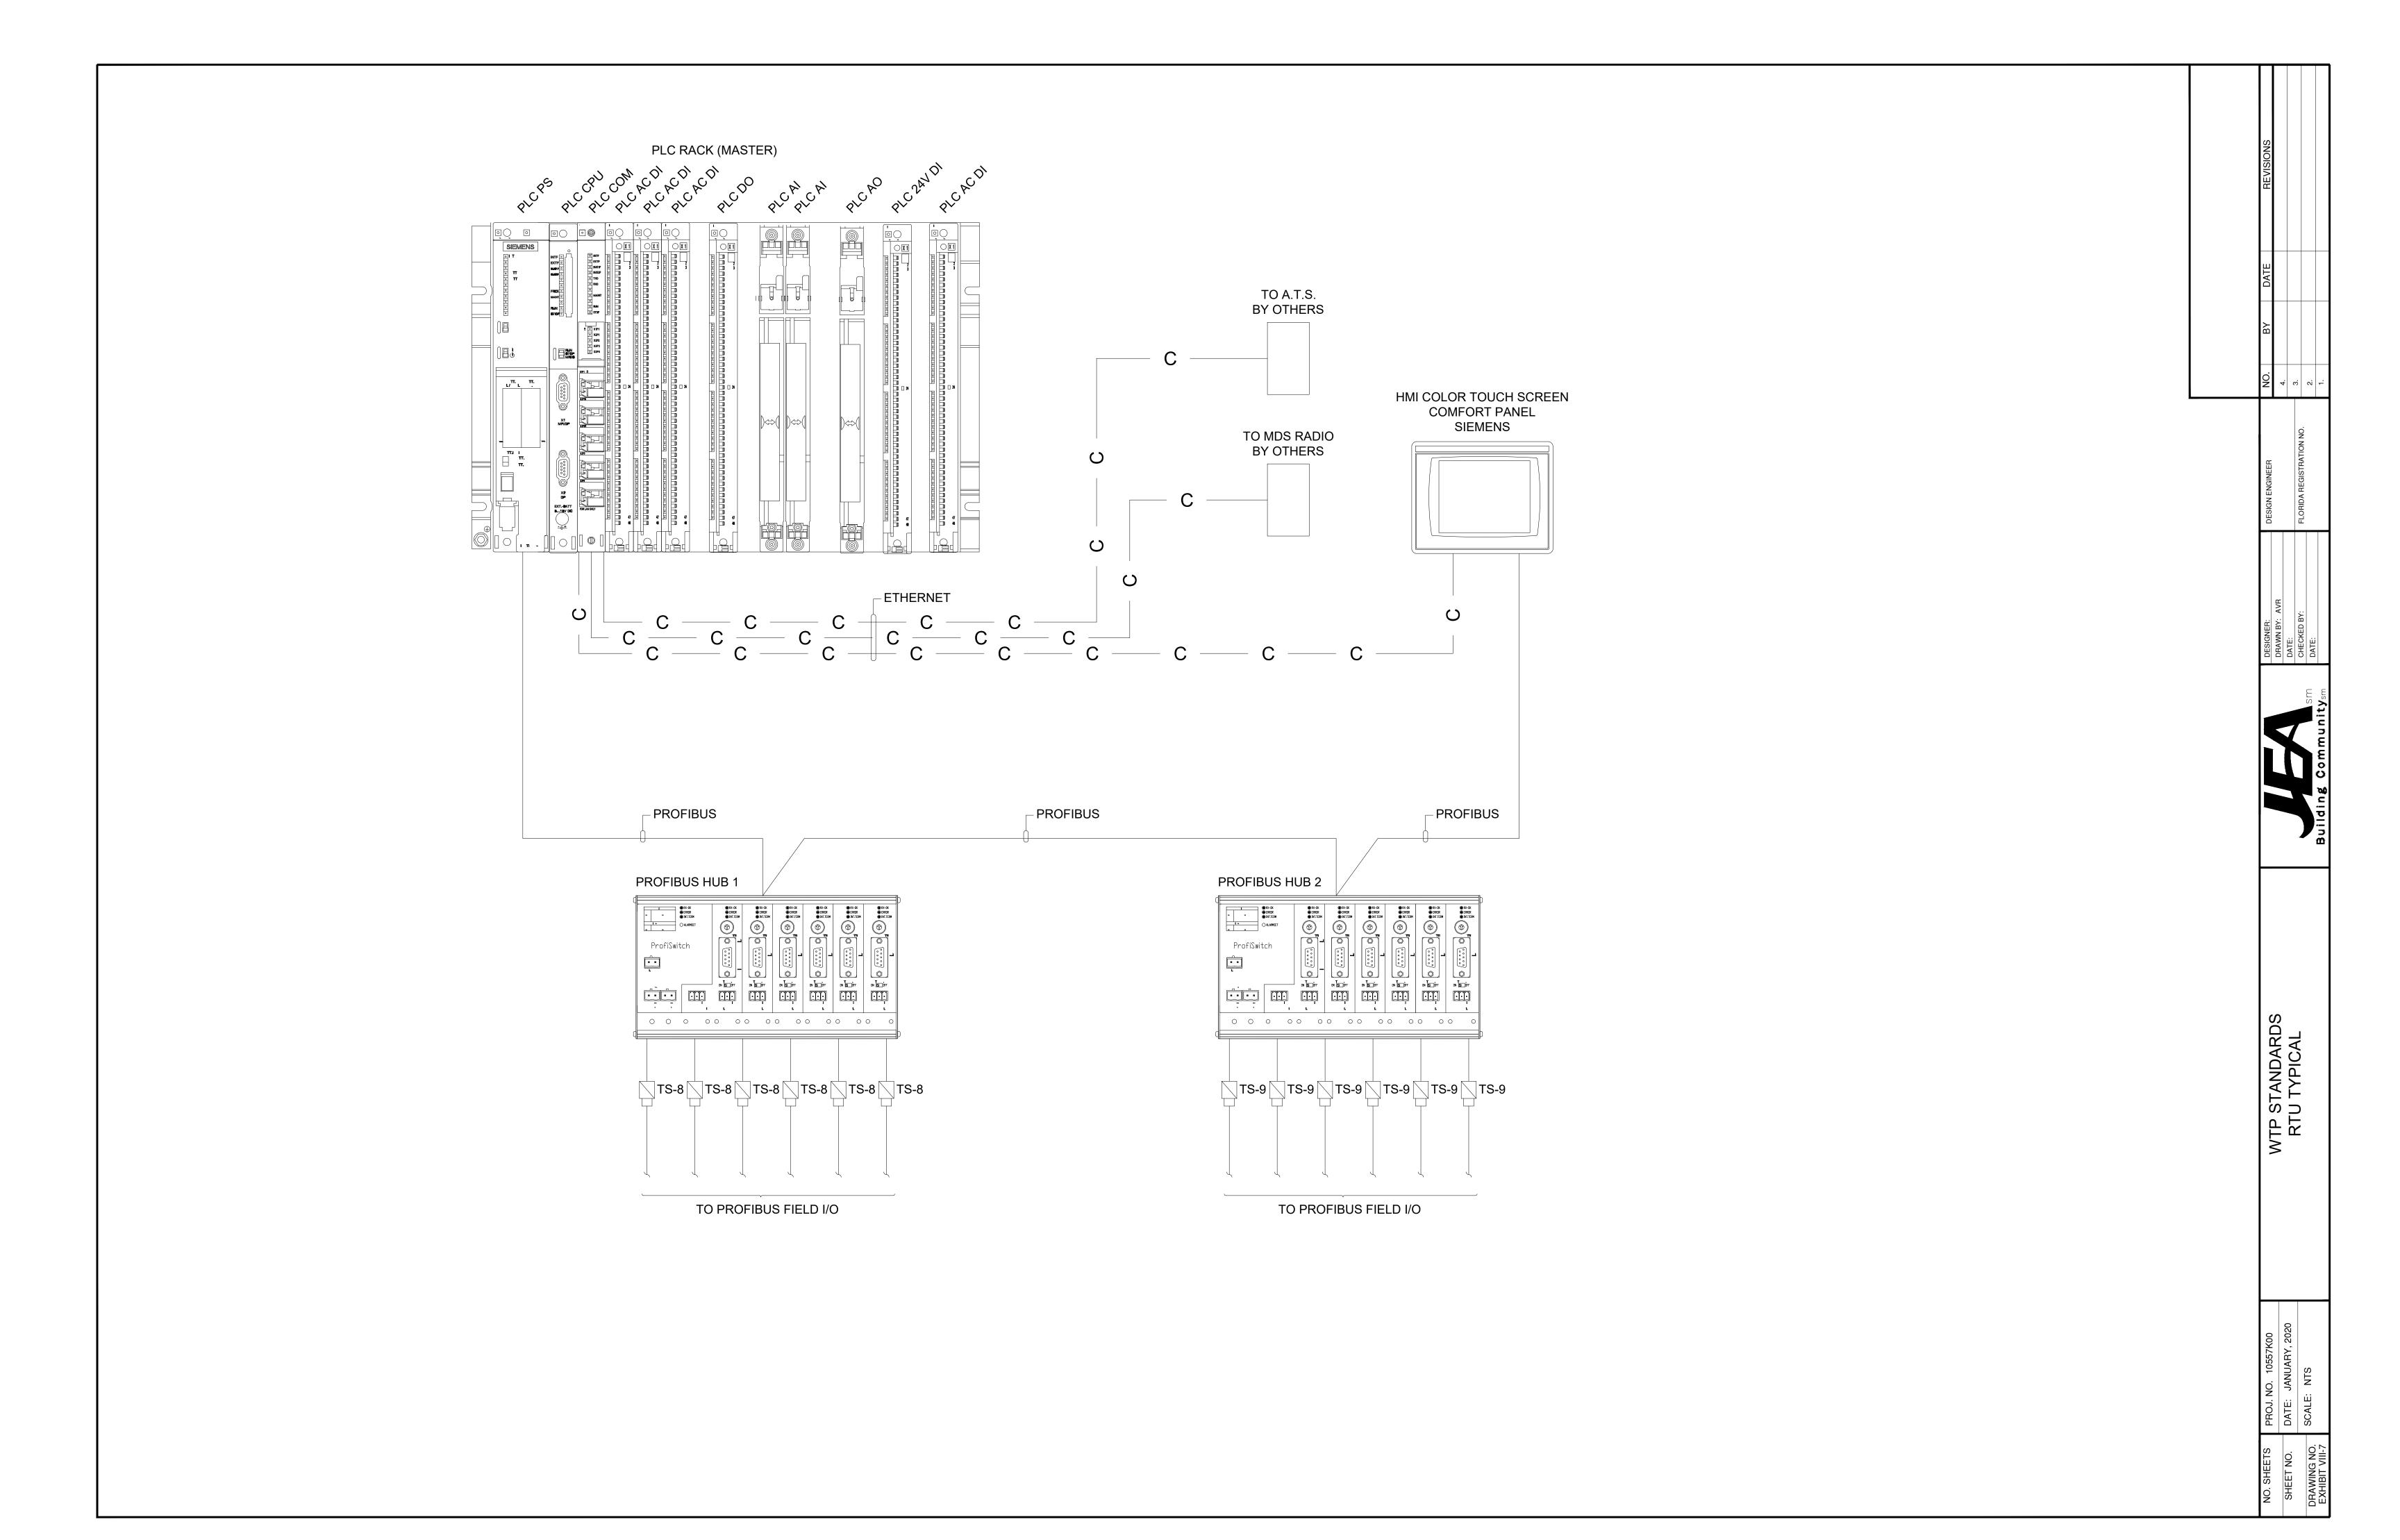


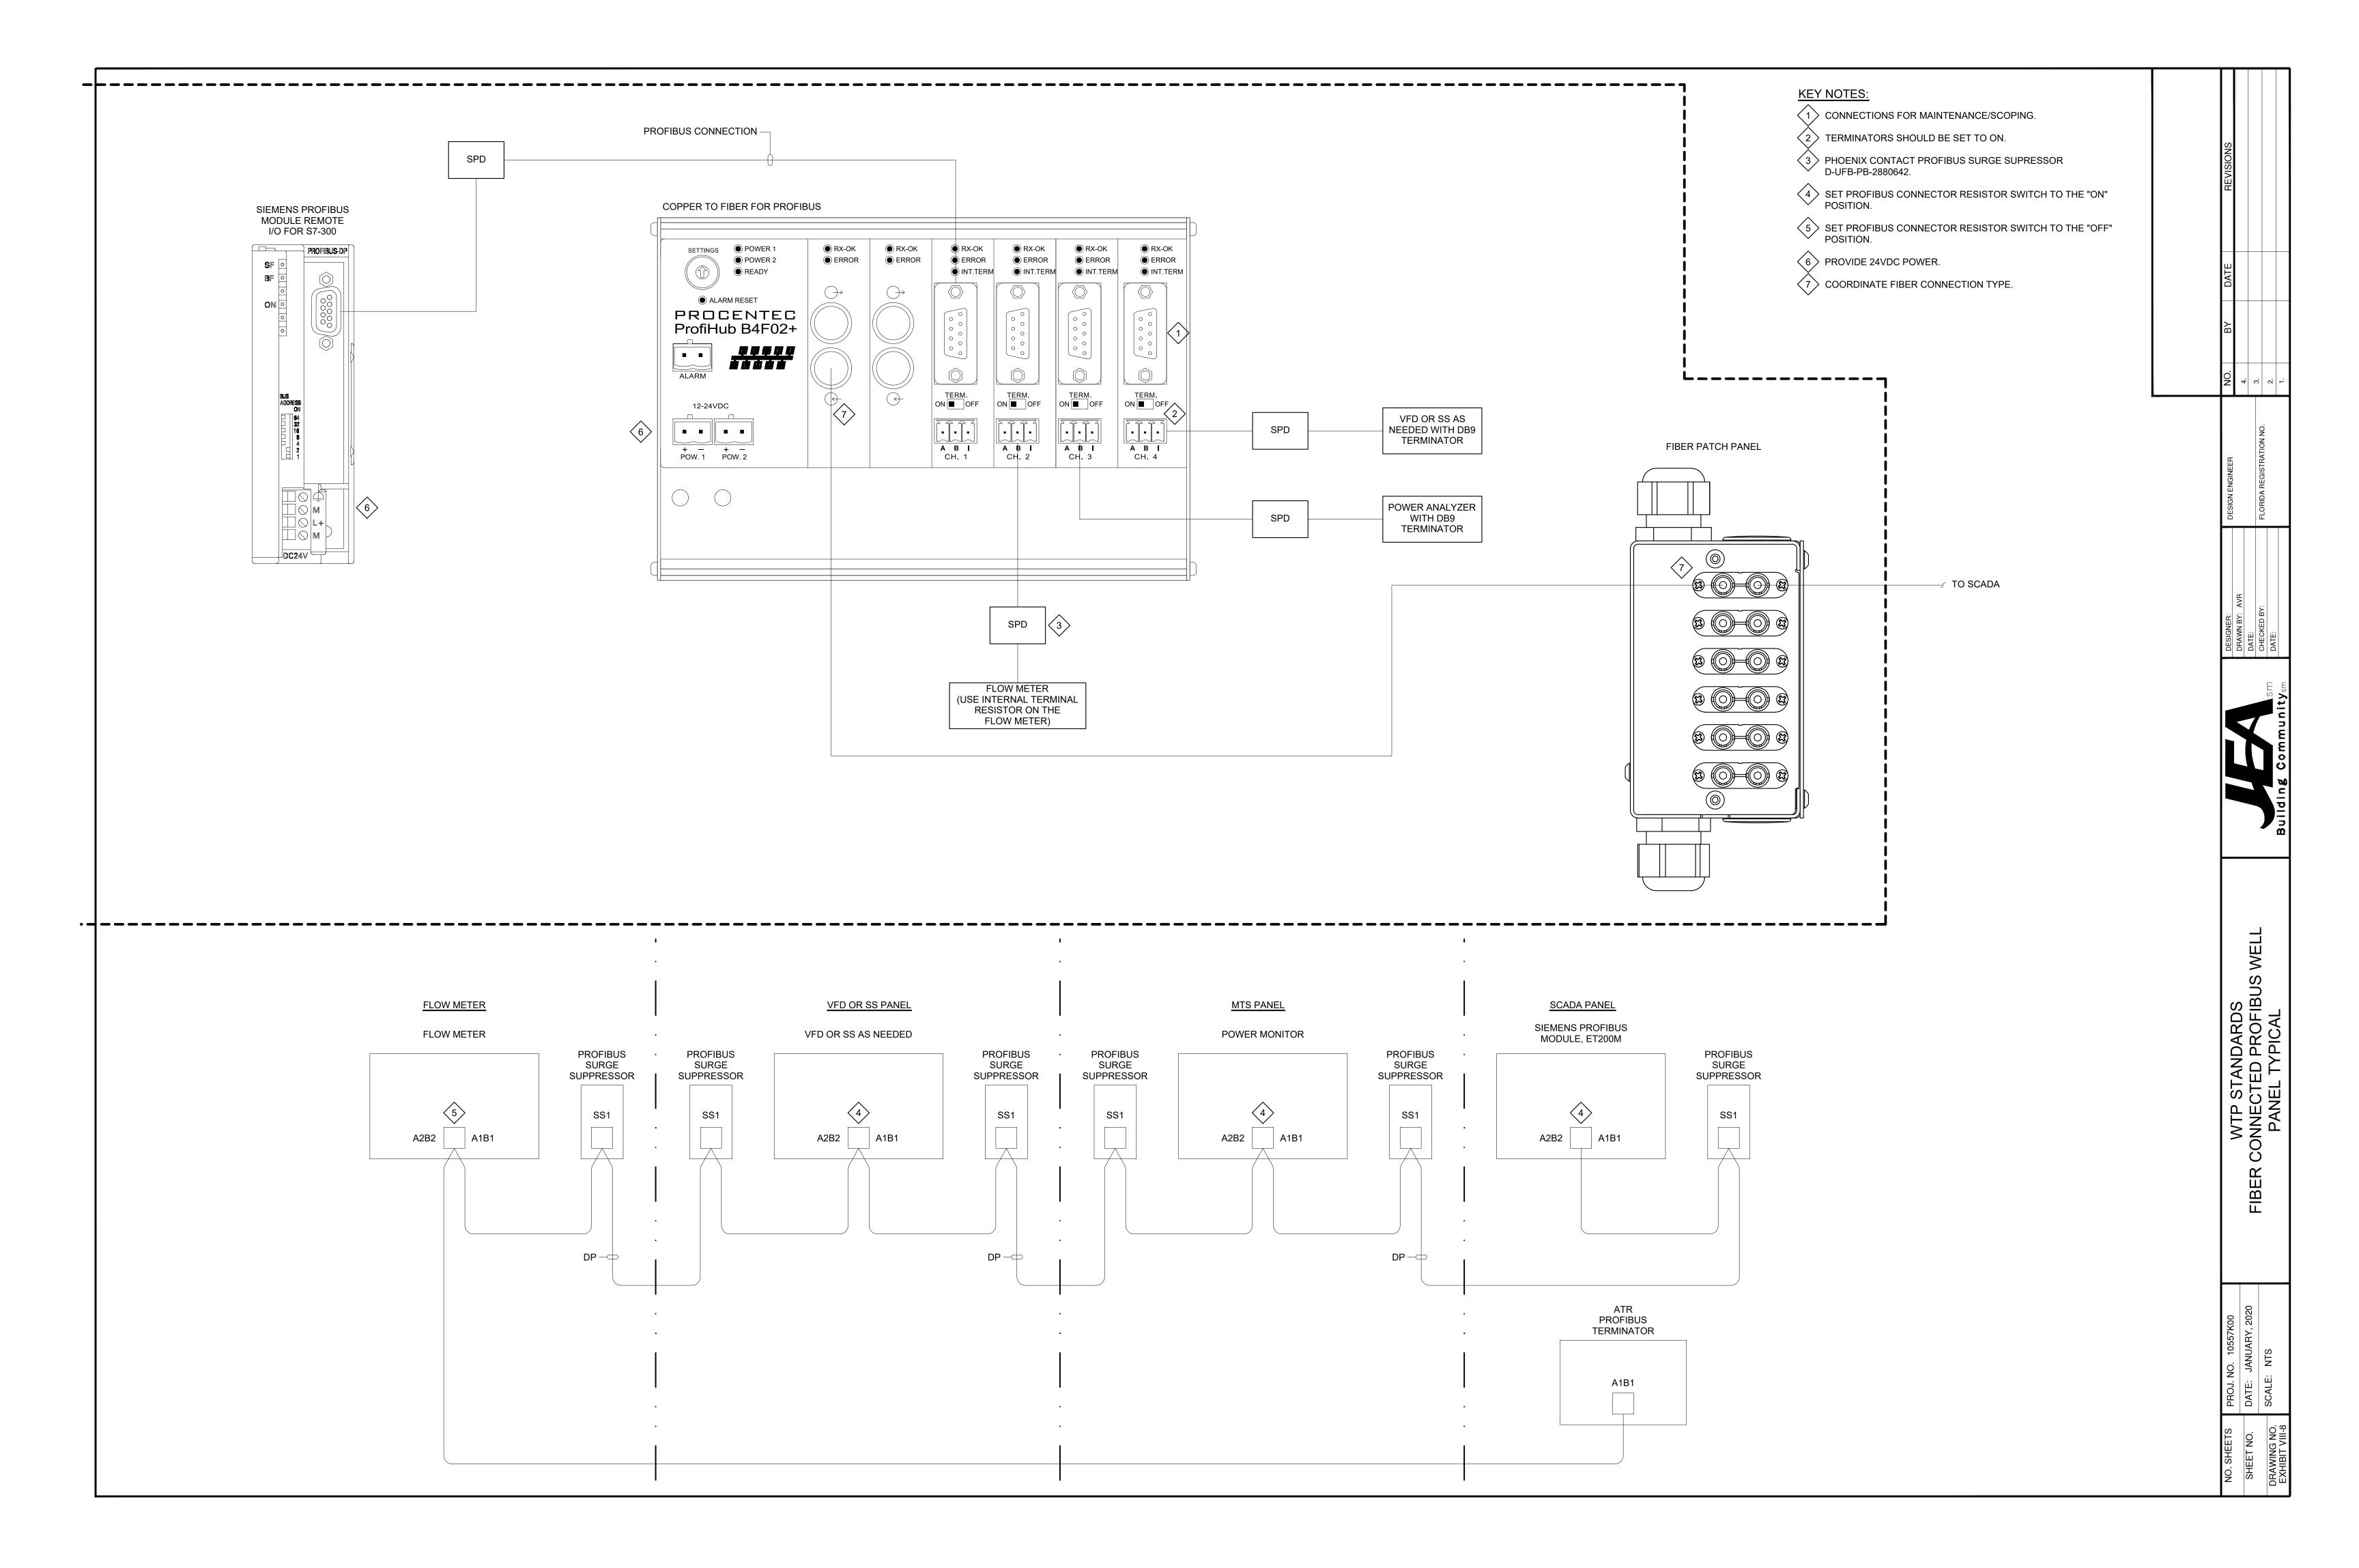

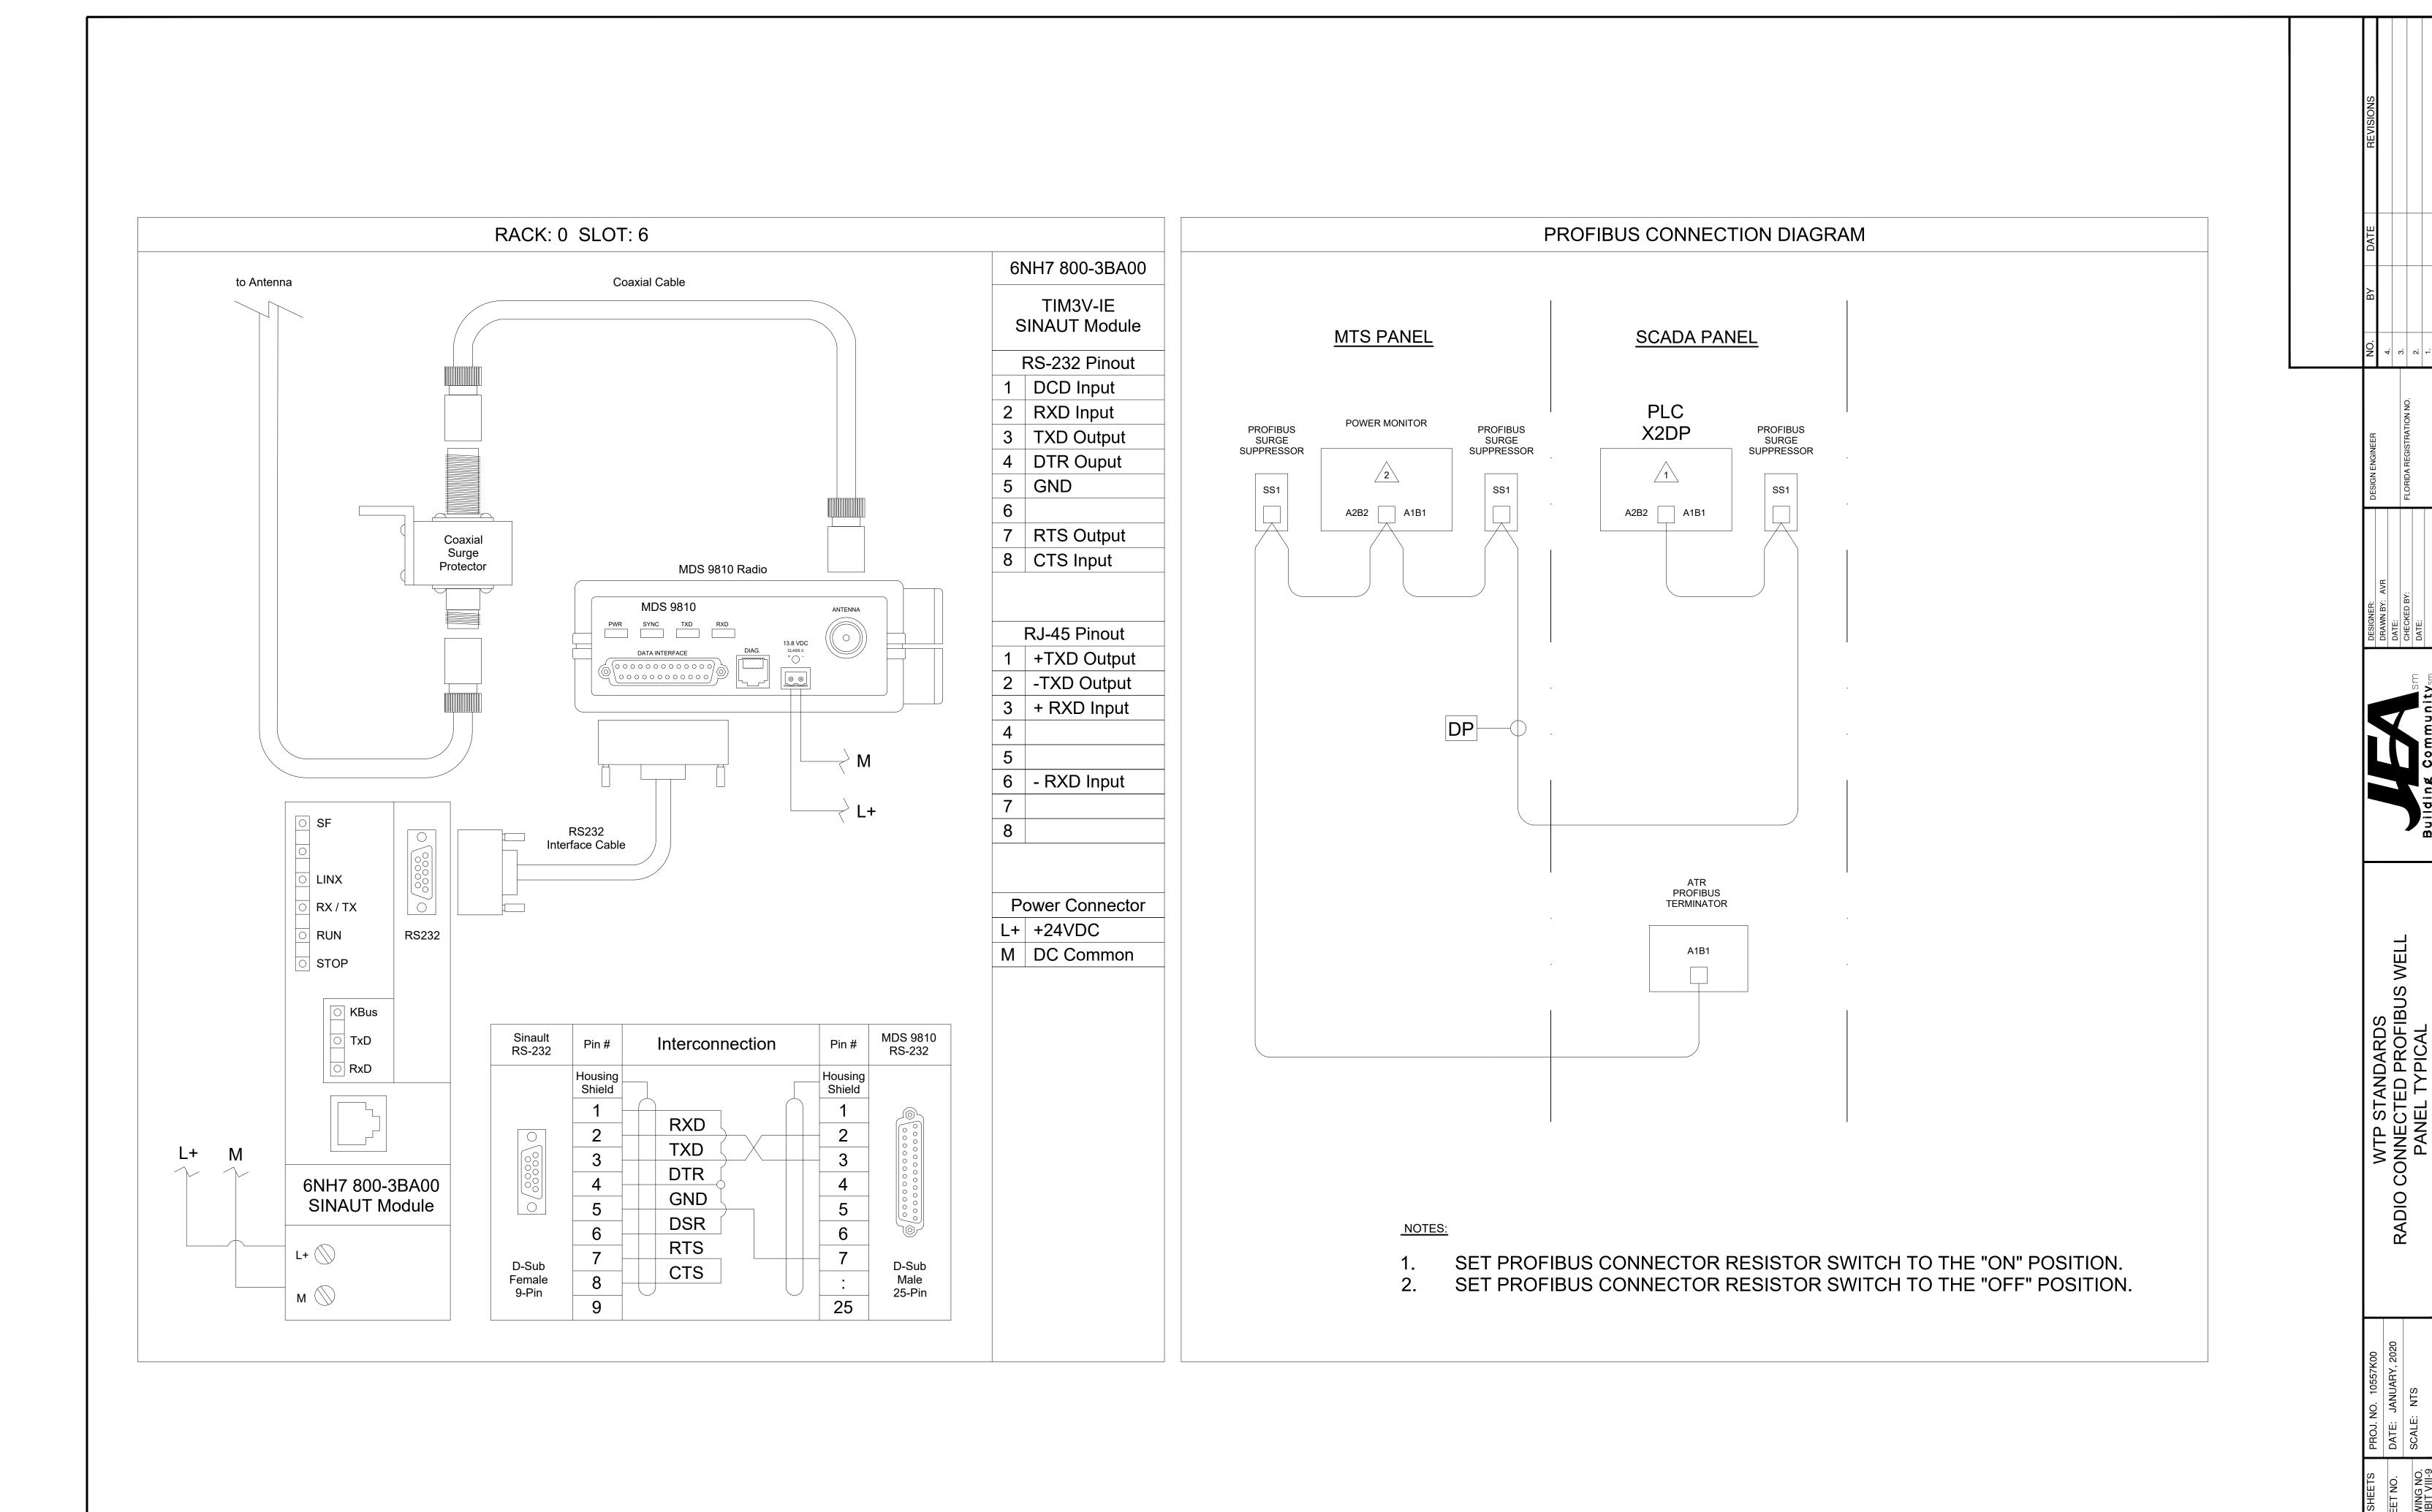

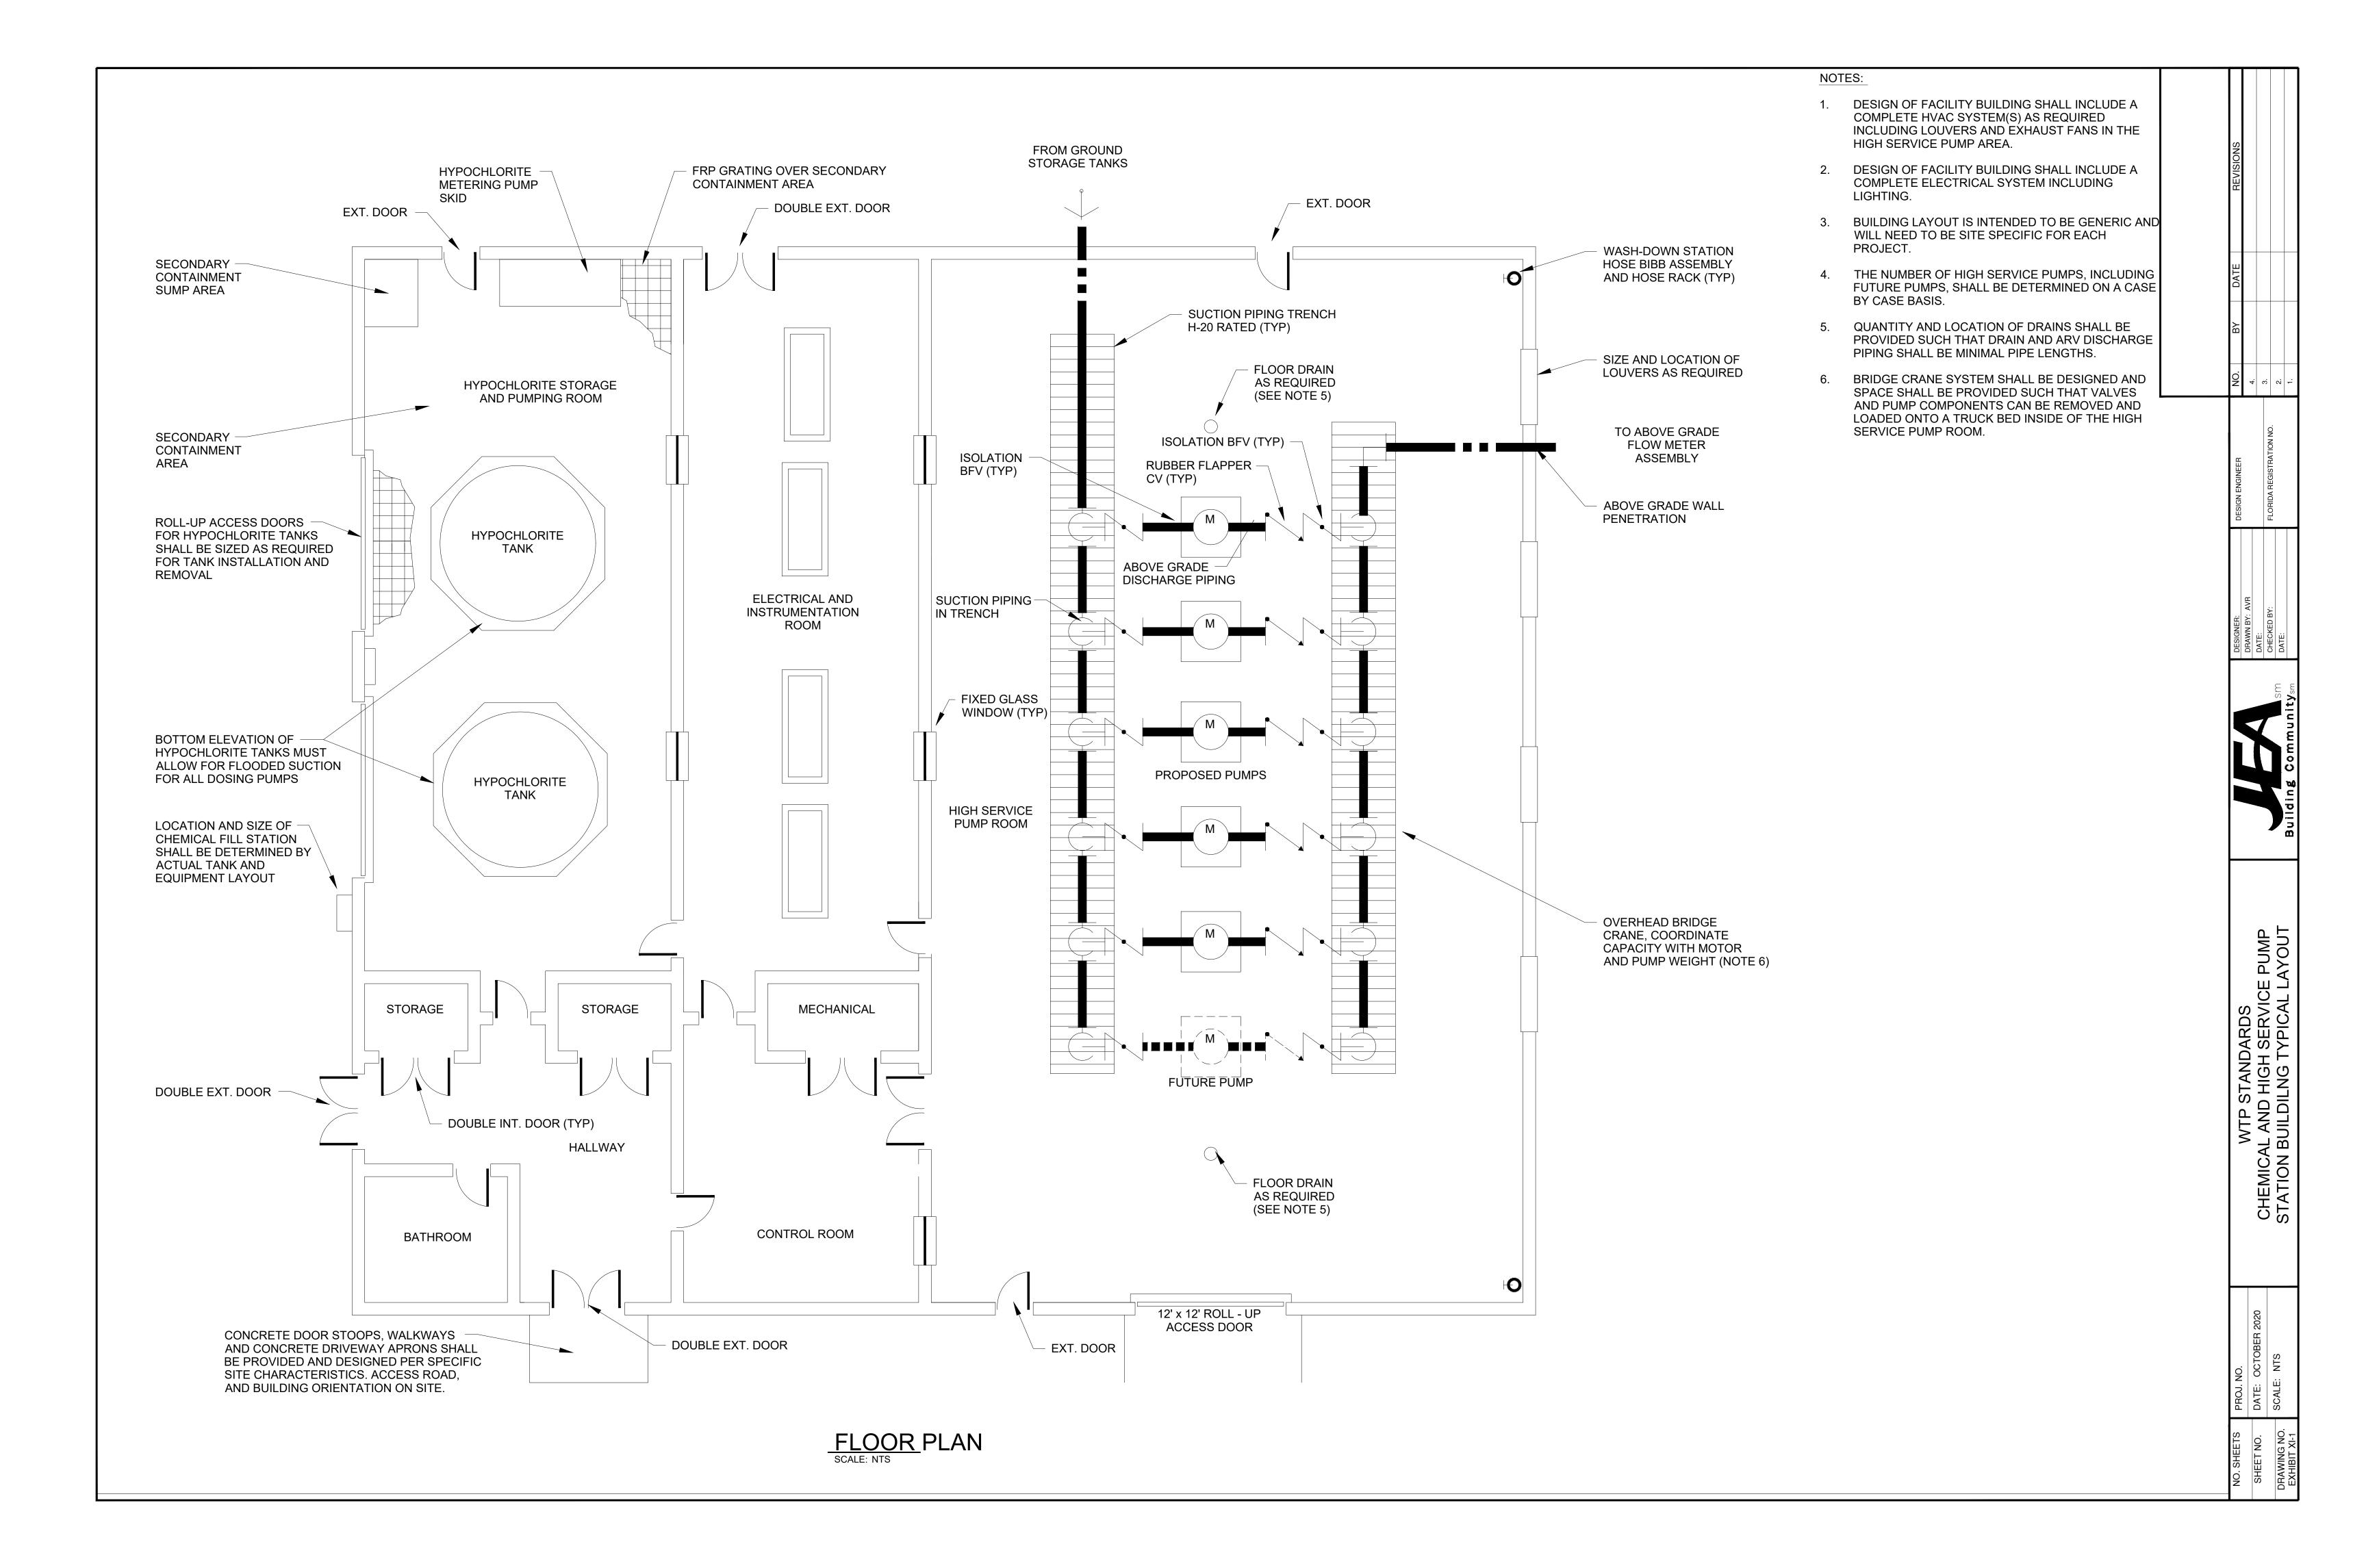

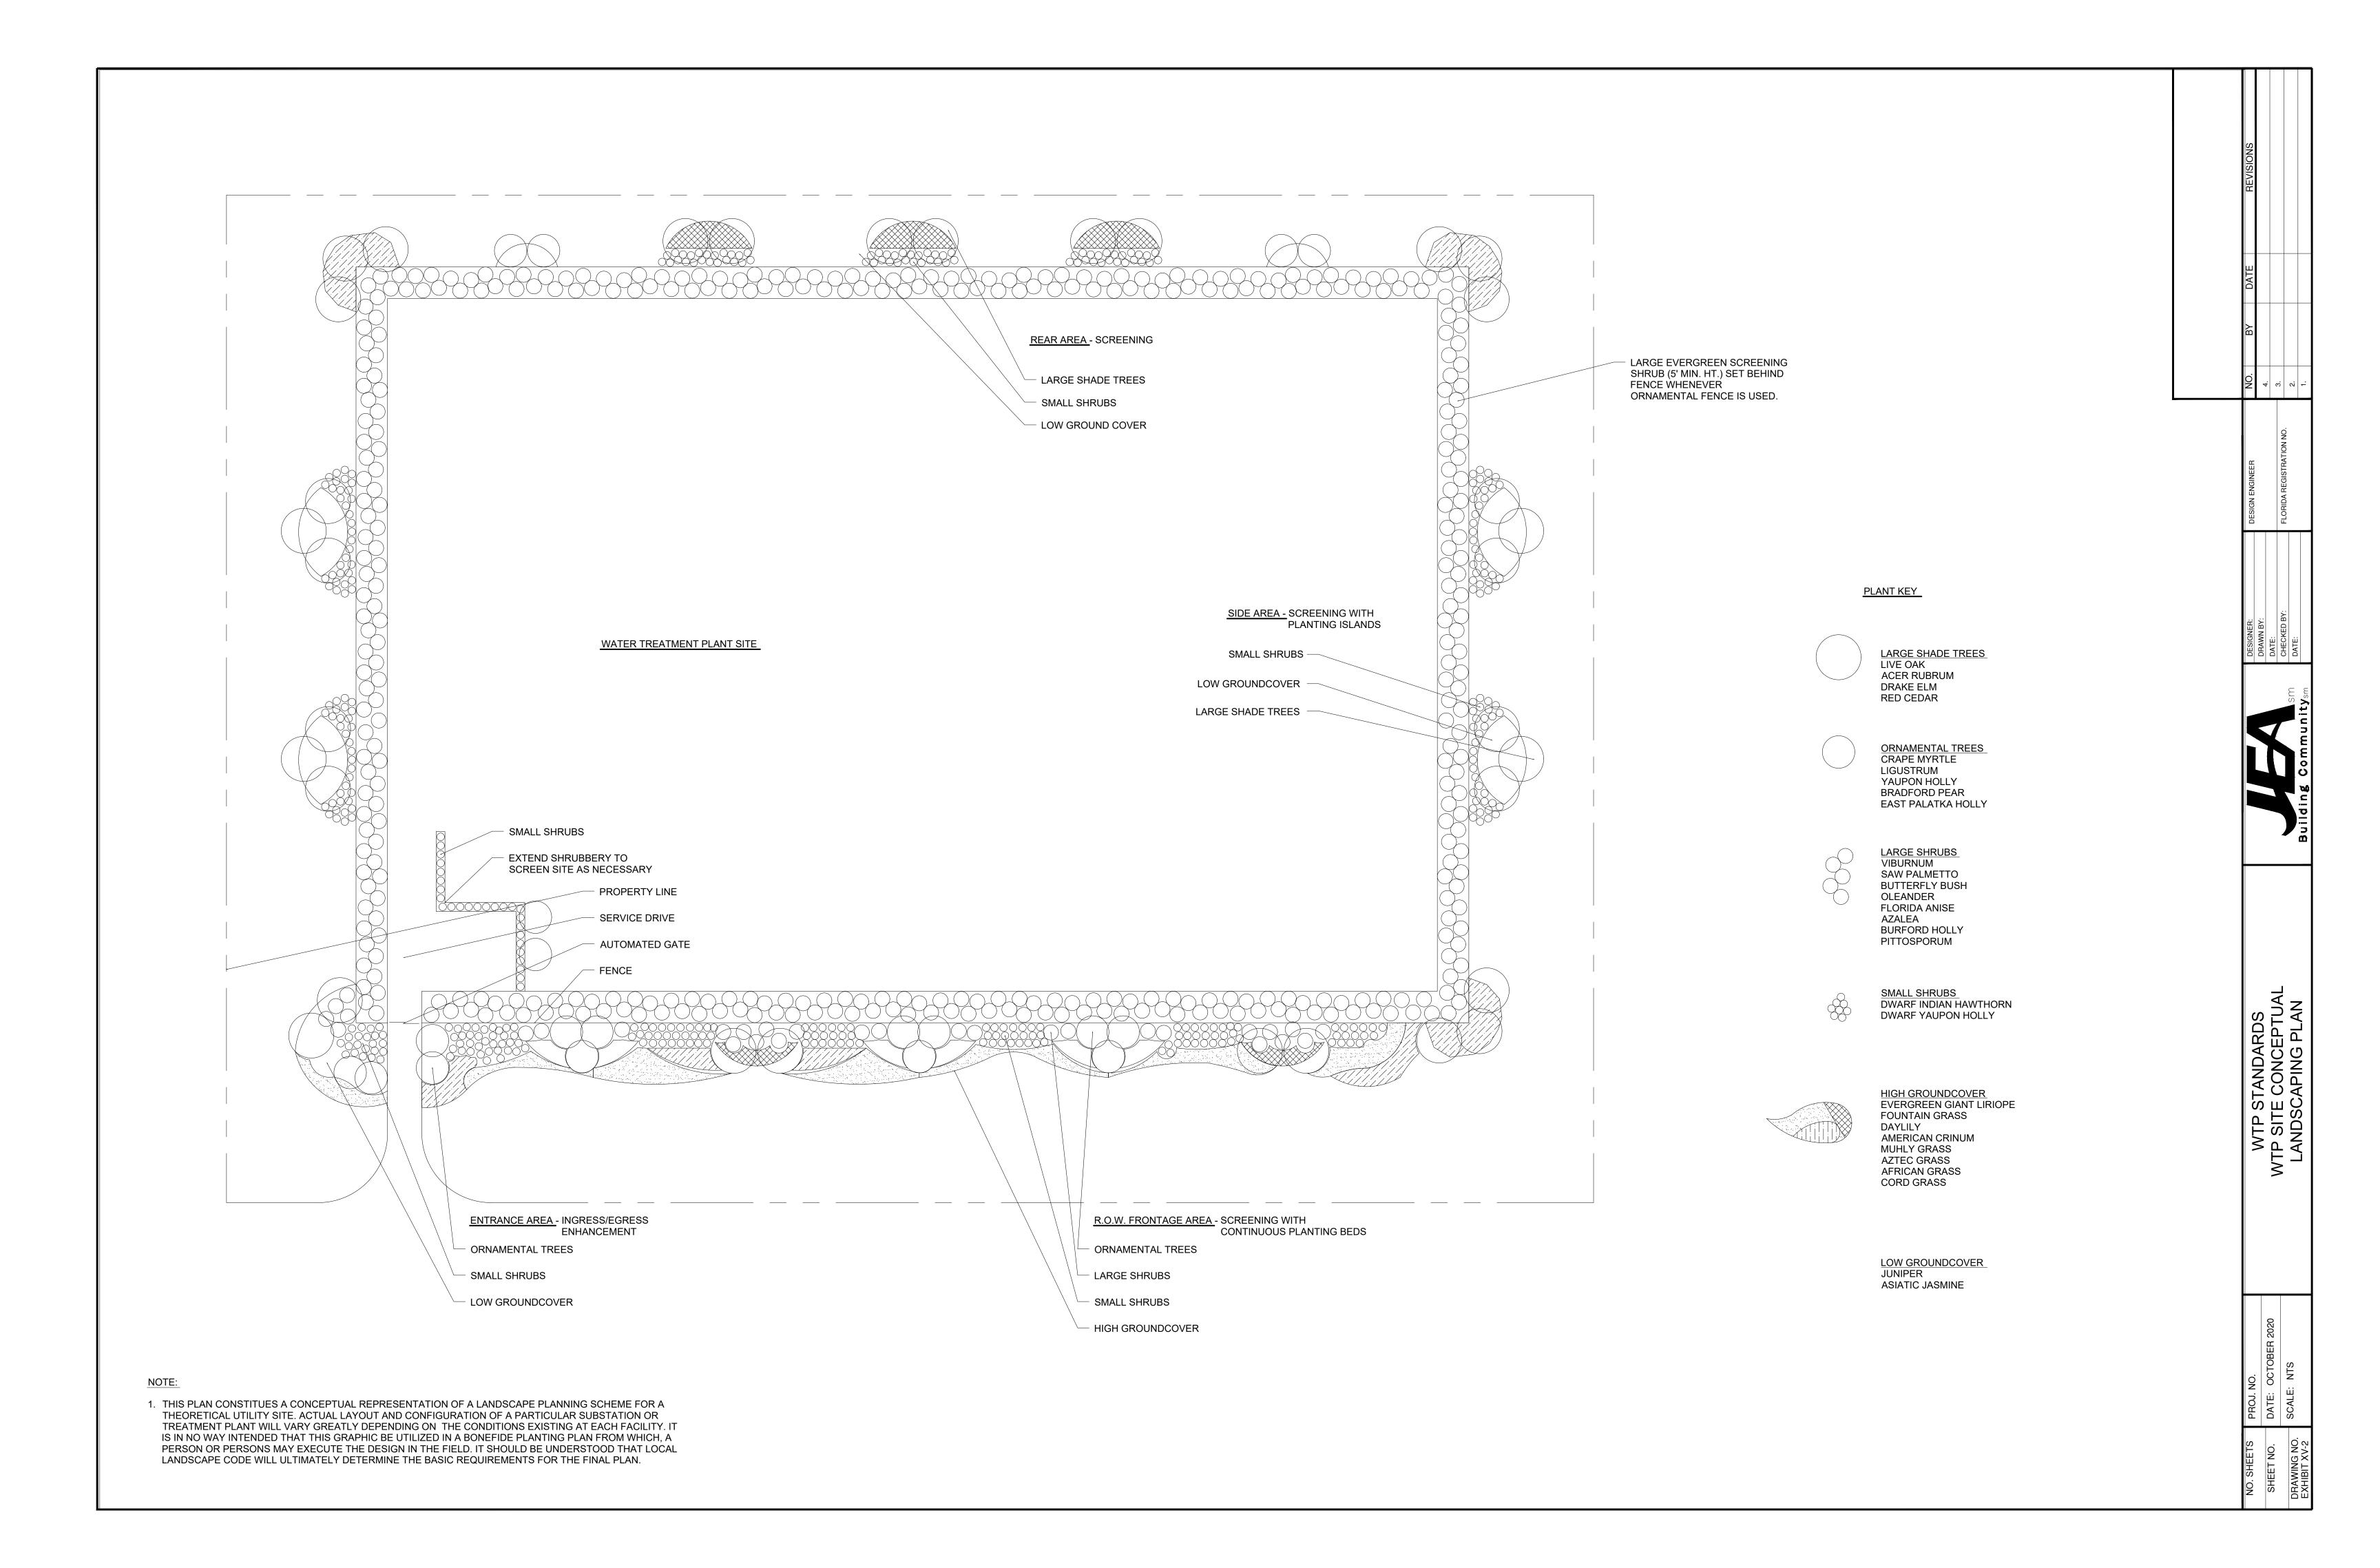

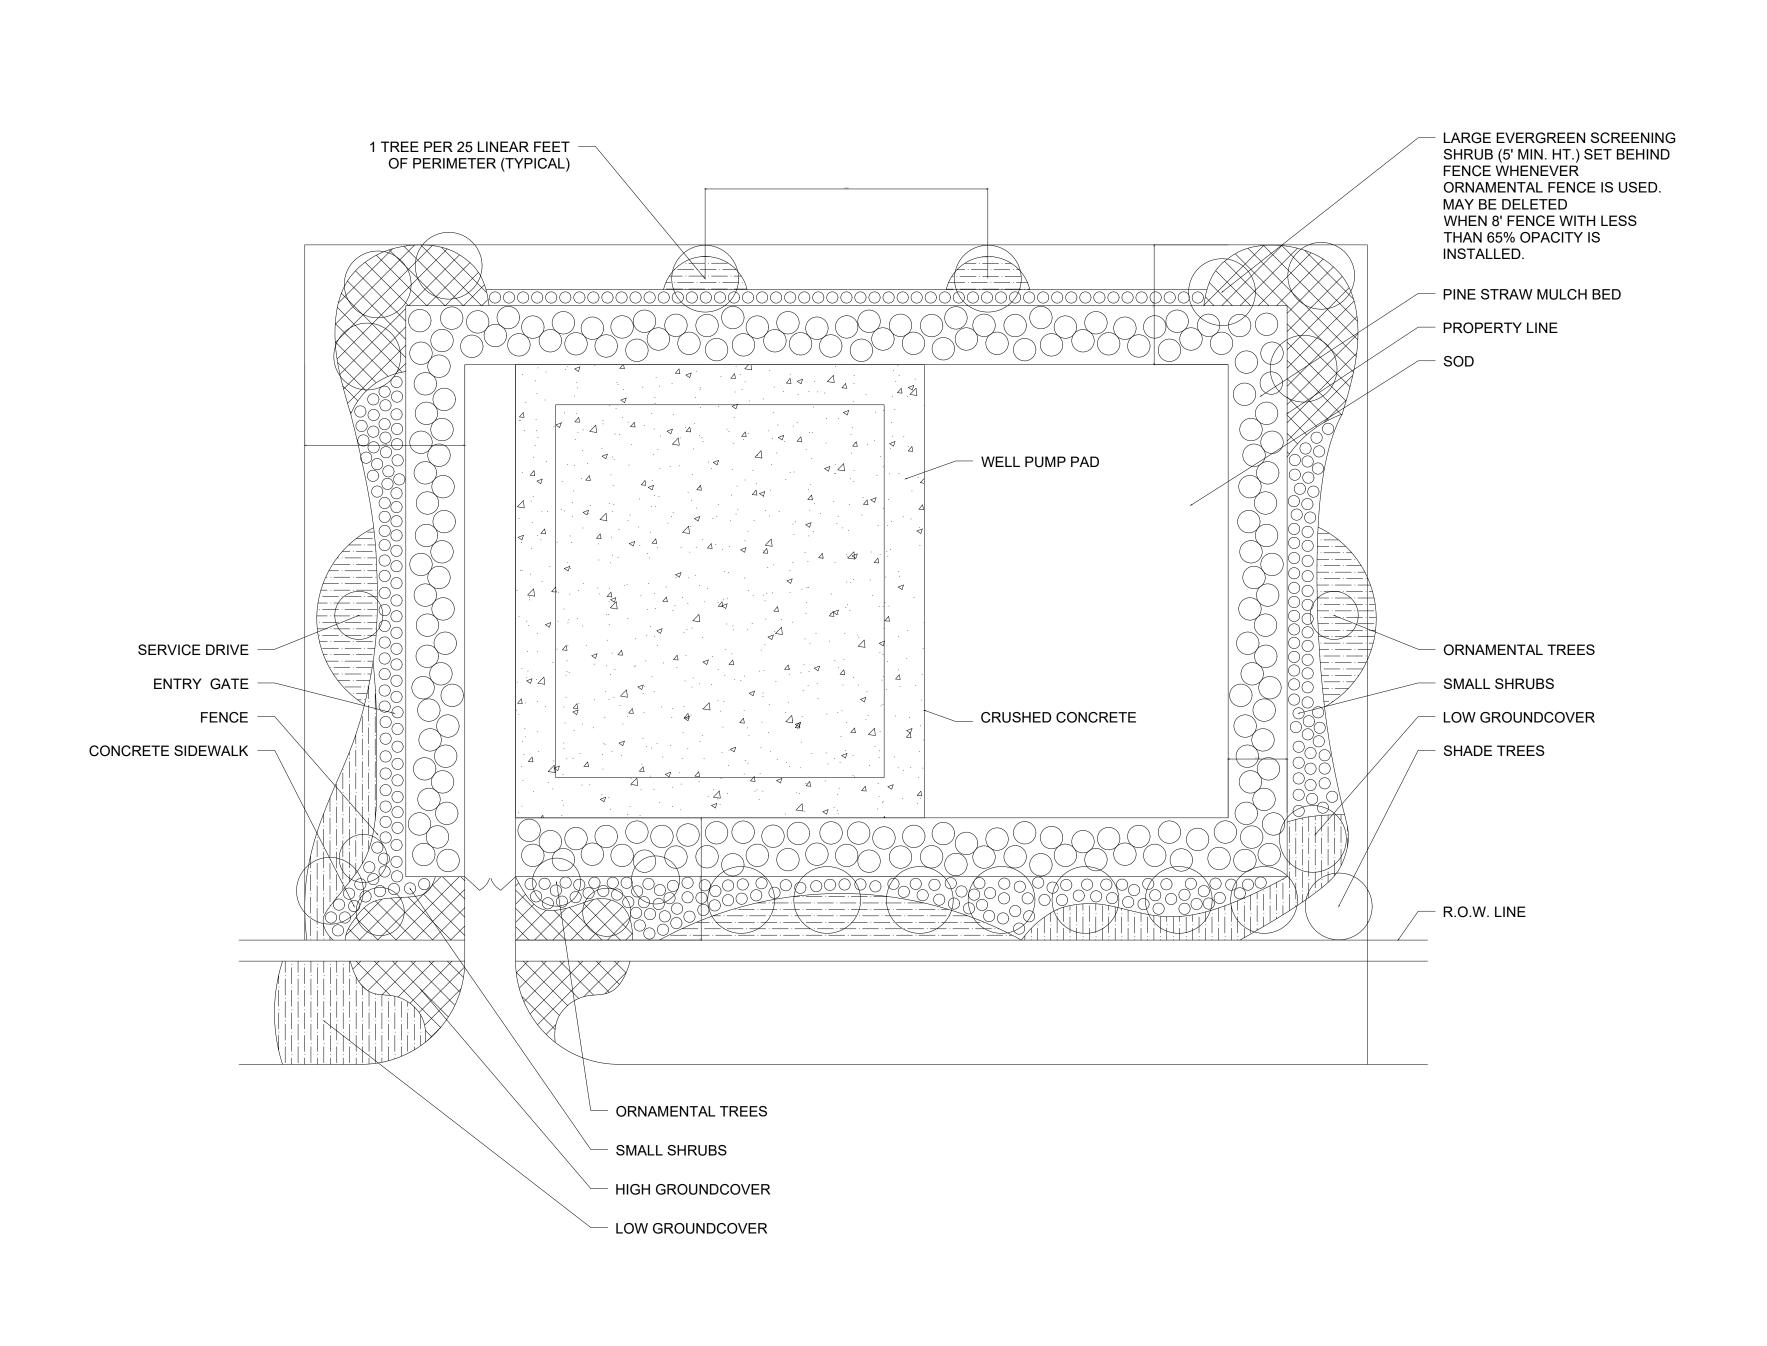

PLANT KEY

LARGE SHADE TREES
LIVE OAK
ACER RUBRUM
DRAKE ELM

ORNAMENTAL TREES
CRAPE MYRTLE
WAS MYRTLE
LIGUSTRUM
YAUPON HOLLY
BRADFORD PEAR
EAST PALATKA HOLLY

LARGE SHRUBS
SAW PALMETTO
BUTTERFLY BUSH
OLEANDER
FLORIDA ANISE
AZALEA
BURFORD HOLLY
VIBURNUM
PITTOSPORUM

SMALL SHRUBS

DWARF INDIAN HAWTHORN

DWARF YAUPON HOLLY

HIGH GROUNDCOVER
EVERGREEN GIANT LIRIOPE
FOUNTAIN GRASS
DAYLILY
AMERICAN CRINUM
MUHLY GRASS
AZTEC GRASS
AFRICAN IRIS
VIRGINIA SWEETSPIRE



LOW GROUNDCOVER
JUNIPER
ASIATIC JASMINE
BIG BLUE LIRIOPE
FLORIDA GAMMA GRASS

NOTE

1. THIS PLAN CONSTITUES A CONCEPTUAL REPRESENTATION OF A LANDSCAPE PLANNING SCHEME FOR A THEORETICAL UTILITY SITE. ACTUAL LAYOUT AND CONFIGURATION OF A PARTICULAR WELL SITE WILL VARY GREATLY DEPENDING ON THE CONDITIONS EXISTING AT EACH FACILITY. IT IS NOT INTENDED TO BE USED AS A PLANTING PLAN, BUT AS A GENERIC GUIDELINE. LOCAL LANDSCAPE CODE WILL ULTIMATELY DETERMINE THE BASIC REQUIREMENTS FOR THE FINAL PLAN.

SHEET NO. DATE: C RAWING NO. SCALE: XHIRIT XV-3























