

500 Water Street, J180 Jacksonville, FL 32202 904.279.3806 Eric Horton@csx.com

Eric Horton Real Estate Analyst

April 3, 2019 Agreement No.: CSX057906
Site Location No.: CSX057906029

Greg Rager
Jacksonville Electric Authority
21 West Church Street
Jacksonville, FL 32202

Dear Greg Rager,

Reference is made to install facilities within CSX Transportation, Inc.'s property by request from Jacksonville Electric Authority

Agreement Date: May 16, 2007 Location: Jacksonville, Duval, FL

Milepost A-632.55
Division Jacksonville
Subdivision Nahunta

**Application Date:** January 18, 2019 **Facility:** Subgrade HDD - Install 4in HDPE SDR11

casing with 3 x 1.25in inner ducts (1 x 72ct

fiber optic cable & 2 x empties) at a

minimum depth below rail to top of casing of

15ft.

Subject to the above referenced company scheduling the work as hereafter references, this letter will serve as formal authority to make the installation at the location, in accordance with specifications outlined in your application and subject to the terms of said Agreements. This letter shall constitute a Supplement to said Agreement; please retain it in your file(s) pertaining to the same.

To schedule the work, please visit the CSX Property Portal to complete the Outside Party Number Request Form. Pursuant to terms of the Agreement, the protection services fees will be invoiced upon completion of installation of the facilities.

Should there be any questions, please feel free to give us a call at the above referenced number.

Sincerely,

**Eric Horton** 

## CSX Transportation (CSX) General Notes (Horizontal Directional Drill (HDD)):

- 1) CSX owns its right-of-way for the primary purpose of operating a railroad, and shall maintain unrestricted use of its property for current and future operations. In the event that relocation of facilities becomes necessary to accommodate the movement of rail traffic, Licensee, at its sole risk and expense, shall be required to relocate and/or remove facilities from the rail corridor of Licensor within a time frame mutually agreed.
- 2) CSX's consent applies to the design and construction of the utility located solely in the right-of-way owned by CSX and assures that CSX and AREMA Standard Specifications are met for tracks owned by others over which CSX operates. It is the utility Owner's (Applicant) responsibility to get permission from the property owner that is other than CSX to access and construct on their property.
- 3) Refer to the CSX's "Interim Guidelines for Horizontal Directional Drilling (HDD) Under the Property and Tracks(s) of CSX Transportation, INC." revised April 3, 2018, "Design & Construction Standard Specifications Pipeline Occupancies" revised June 5, 2018 and "Design & Construction Standard Specifications Wireline Occupancies" revised December 16, 2016.
- 4) CSX's signal facilities and/or warning devices at proposed facility crossing, i.e. cantilevers, flashers, and gates are to be located prior to installation.
- 5) No entry or construction on CSX's railroad corridor is permitted until the utility encroachment review and approval process is completed, you are in receipt of a fully executed License agreement and you have obtained authority from the local Road Master.
- 6) A bore plan and fraction mitigation plan (reference CSX' Bore Template and Fraction Mitigation Plan(s)), if not provided and approved during the application review, must be submitted to CSX's representative for review and approval prior to construction.
- 7) Drilling fluid with bentonite additive is required.
- 8) Once the bore enters CSX's property, the work must be continuous until drilling is complete and the pipe is pulled in place and the bore must be tracked constantly, with the location and depth marked every 10 feet.
- 9) Casing pipe ends must be sealed to prevent entrance of foreign materials and all drill heads are required to be on site for expected and unexpected soil conditions.
- 10) Dry and wet bores (jetting) are not allowed.
- 11) Trailing rods must be utilized for all back reaming.
- 12) At locations where open cut is permitted on CSX's right-of-way and/or railroad corridor, contractor must comply with CSX's D&C Standard Specifications section 4.1.7 Open Cut. Please reference this guidance for instructions on restoring site.
- 13) No entry or construction on CSX's railroad corridor is permitted until the utility encroachment review and approval process is completed, you are in receipt of a fully executed License agreement and you have obtained authority from the local Road Master.
- 14) Abandoned pipelines shall be removed or completely filled with cement grout, compacted sand, or other methods, as approved by CSX. Abandoned manholes and other structures shall be removed to a minimum depth of 2 feet below finished grade and completely filled with cement grout, compacted sand, or other methods as approved by CSX.
- 15) Pipeline encroachment shall be prominently marked at both sides of the CSX's property lines by durable, weatherproof signs located over the centerline of the pipe in accordance with CSX's D&C Standard Specifications.
- 16) If required, a dewatering plan in accordance with CSX's D&C Standard Specifications will be submitted to the CSX representative for review and approval prior to any dewatering operations.
- 17) Blasting is not permitted on CSX's property.
- 18) CSX does not grant or convey an easement for this installation.



# PROJECT OVERALL LOCATION

AND ROUTING MAP

NOT TO SCALE



# JEA - FIBER BUILD PROJECT DINSMORE SUBSTATION TO GARDEN CITY AND WEST LAKE SUBSTATIONS BLACK & VEATCH PROJECT 400631 PERMIT APPLICATION DRAWINGS FOR CSX RAIL ROAD

PROJECT DRAWING LIST

SHEET	DRAWING	DRAWING
COUNT	NUMBER	TITLE
1 OF 5	E0-1	OVERALL SITE PLAN & DRAWING LIST
2 OF 5	E0-2	STANDARD DETAILS NOTES & LEGEND
3 OF 5 4 OF 5 5 OF 5	E1-1 E1-2 E1-3	P&P AND ENLARGED SITE PLAN ENLARGED PLAN & CONSTRUCTION NOTES ENLARGED SECTION & NOTES



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CONSTRUCTION
FOR PERMITTING
PURPOSES
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& Jacksonville, Florida 32258

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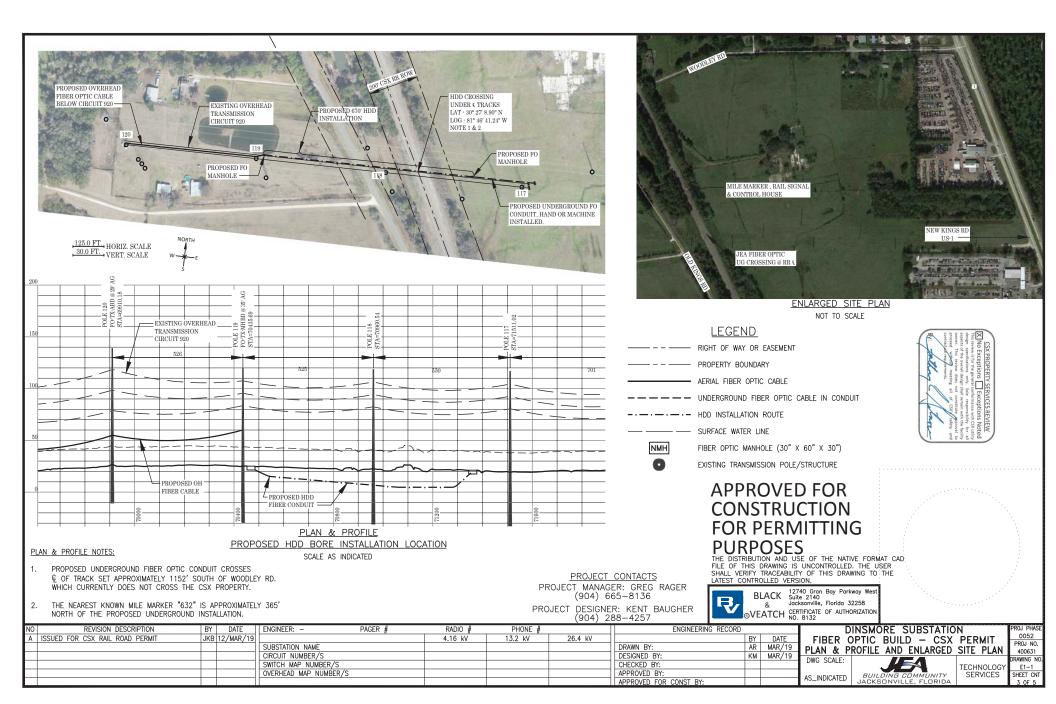
CONTACTS
PROJECT MANAGER: GREG RAGER
(904) 665-8136
PROJECT DESIGNER: KENT BAUGHER
(904) 288-4257

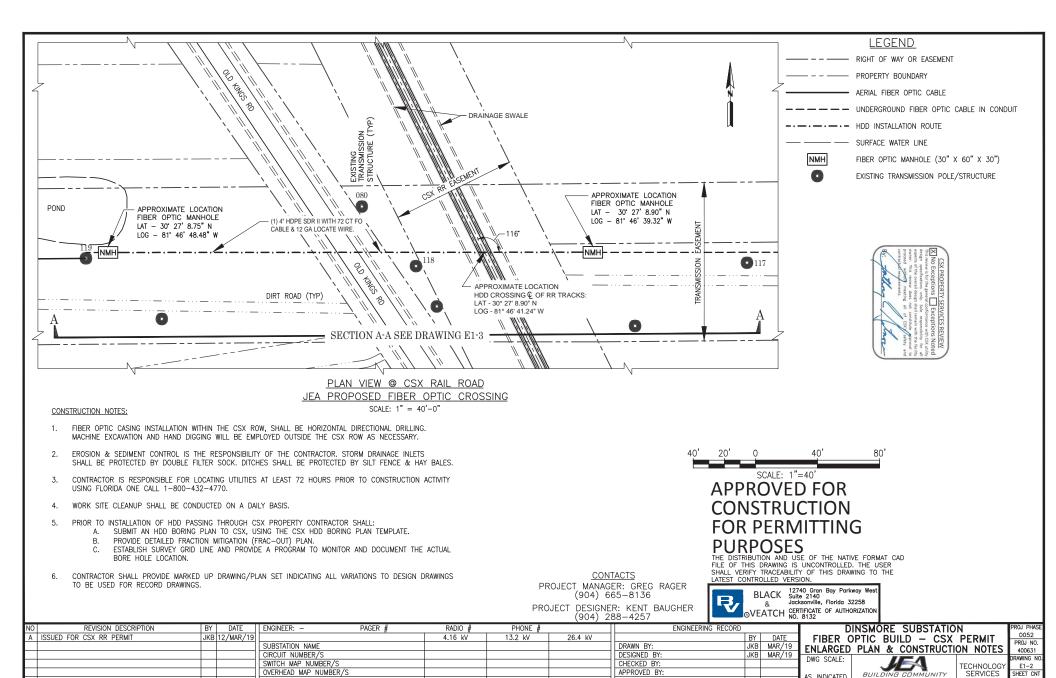
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Α	ISSUED FOR CSX RR PERMIT	JKB	12/MAR/19			4.16 kV	13.2 kV	26.4 kV	
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CHECKED BY:				DWG
APPROVED BY:				AS I
APPROVED FOR CONST BY:				A5_I

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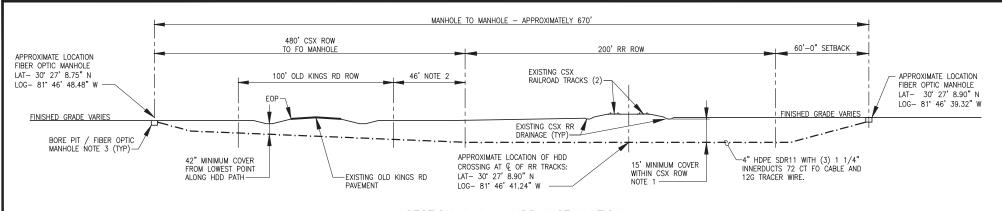
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AS\_INDICATED

APPROVED FOR CONST BY:



# SECTION A-A - HDD INSTALLATION CROSSING CSX AND OLD KINGS ROAD SCALE: 1" = 40'-0"

LEGEND

RIGHT OF WAY OR EASEMENT

—— PROPERTY BOUNDARY

AERIAL FIBER OPTIC CABLE

- — — — UNDERGROUND FIBER OPTIC CABLE IN CONDUIT

----- SURFACE WATER LINE

NMH FIBER OPTIC MANHOLE (30" X 60" X 30")

EXISTING TRANSMISSION POLE/STRUCTURE

### SECTION NOTES:

- 1. COVER DEPTH WITHIN CSX PROPERTY TO BE DETERMINED BY LOWEST ELEVATION ALONG PATH.
- DISTANCE BASED ON HDD ROUTE LOCATION WITHIN PROPERTY ADJACENT TO CSX ROW AND OLD KINGS RD ROW.



**CONTACTS** 

PROJECT MANAGER: GREG RAGER

(904) 665-8136

PROJECT DESIGNER: KENT BAUGHER



**PURPOSES** 

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г				SUBST	ATION NAME					DRAWN BY:
				CIRCUI	T NUMBER/S					DESIGNED E
г				SWITCH	MAP NUMBER/S					CHECKED B
				OVERH	EAD MAP NUMBER/S					APPROVED I
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DINSMORE SUBSTATION
FIBER OPTIC BUILD — CSX PERMIT
ENLARGED SECTION AND NOTES

DWG SCALE:

AS\_INDICATED | BUILD IN GOD MILIUITY |
ASSERBANGULE OF TRANSPORTED | SERVICES

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