
FOR GREENLAND WATER TREATMENT PLANT - BACKUP WELL (WELL NO. 3) WELL DRILLING

JEA PROJ NO.: 8004372

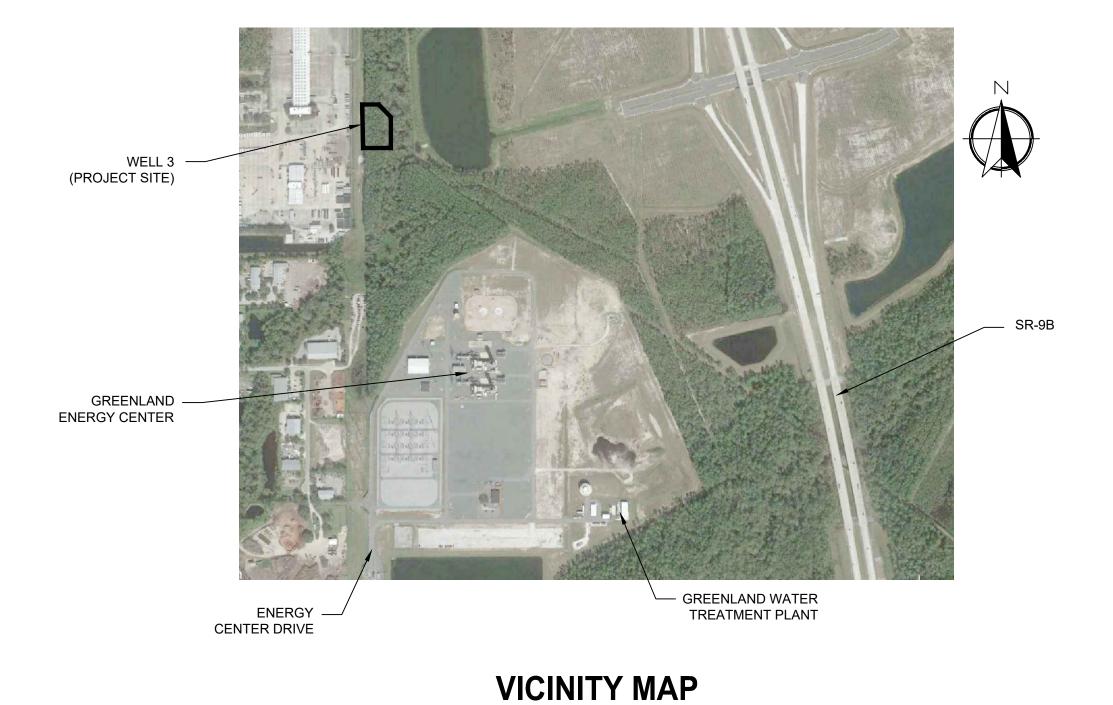





8381 Dix Ellis Trail, Suite 400 Jacksonville, FL 32256 Tel: (904) 731-7109 FL COA No. EB-0000020



INDEX OF DRAWINGS:

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DETAILS PROVIDED ON THE ATTACHED DRAWINGS GOVERN OVER THOSE LISTED ABOVE. FOR DETAILS NOT PROVIDED IN THE DOCUMENTS, PLEASE REFER TO JEA STANDARD DETAILS.

GROUNDING PLAN

GROUNDING DETAILS

ELECTRIC SINGLE LINE DIAGRAM

PS-STD-6

PS-STD-7

PS-STD-8

STANDARD DRAWINGS ARE APPLICABLE FOR ALL PROJECTS, INCORPORATED BY REFERENCE AND ARE AVAILABLE AT JEA.COM

■ 11. CONTRACTOR SHALL REPLACE EXISTING WATER METER BOXES WHEN DEEMED NECESSARY BY

12. CONTRACTOR TO PROVIDE ADDITIONAL DEPTH OF BURY VIA PIPE JOINT DEFLECTION TO ACCOMMODATE VALVE SELECTION PER JEA STANDARDS.

■ 13. WATER METERS MAY REQUIRE RELOCATION FOR CONSTRUCTION, CONTRACTOR SHALL CONTACT JEA METER DEPARTMENT AND RELOCATE WATER METERS AS NECESSARY.

☐ 🔀 14. PRIOR TO COMMENCING ANY EXCAVATION OR GRADING, THE CONTRACTOR SHALL OBTAIN ALL GEOTECHNICAL AND TOPOGRAPHIC SURVEY DATA AND LOCATIONS OF ABOVE GROUND AND UNDERGROUND UTILITIES. SHOULD THE CONTRACTOR DISCOVER ANY INACCURACIES, ERRORS OR OMISSIONS IN THE SURVEY DATA. HE SHALL IMMEDIATELY NOTIFY THE DESIGN ENGINEER IN ORDER THAT PROPER ADJUSTMENTS CAN BE ANTICIPATED AND ORDERED.

■ 15. SHEET PILING WILL BE REQUIRED ON ALL EXCAVATIONS DEEPER THAN 16 FEET.

☐ 16. ZERO JOINT DEFLECTION WILL BE ALLOWED ON 20" OR LARGER PVC PRESSURE PIPE. THE MAXIMUM JOINT DEFLECTION SHALL BE LIMITED TO 60% OF THE PIPE MANUFACTURER'S RECOMMENDATION ON ALL 20" OR LARGER DUCTILE IRON PRESSURE PIPE. THE CONTRACTOR SHALL PROPERLY INSPECT THE INSTALLATION OF ALL PIPE JOINTS TO ENSURE THESE JOINT DEFLECTION LIMITS ARE NOT EXCEEDED. SPLIT DEFLECTION ANGLES(HORIZONTAL AND VERTICAL) EQUALLY BETWEEN

■ 17. THE CONTRACTOR SHALL INSTALL TWO 45° BENDS IN LIEU OF A SINGLE 90° DI MJ BEND AT CHANGES IN THE PIPELINE ALIGNMENT AND AS SHOWN ON THE DRAWINGS. IF THE SEPARATION BETWEEN THE TWO 45° BENDS IS LESS THAN 10 FEET, THE BENDS SHALL BE RESTRAINED TOGETHER WITH TIE-RODDING PER THE FITTING MANUFACTURER'S RECOMMENDATION.

☐ 🙀 18. CONTRACTOR SHALL FOLLOW JEA STANDARDS AND ALL APPLICABLE REGULATORY AGENCY REQUIREMENTS IF ANY ASBESTOS CEMENT PIPE IS IMPACTED DURING CONSTRUCTION.

■ 19. THE CONTRACTOR SHALL RESTRAIN ALL JOINTS ON ANY EXISTING PRESSURE MAINS THAT ARE

🕱 📋 20. THE CONTRACTOR SHALL BE RESPONSIBLE FOR PRESSURE AND LEAKAGE TESTING ALL NEW WATER MAINS IN THIS PROJECT. THE PRESSURE TEST SECTIONS SHALL BE BETWEEN ADJACENT PERMANENT INLINE VALVES AND A STUB-OUT PLUG. AFTER SUCCESSFUL COMPLETION OF THE PRESSURE TEST, THE CONTRACTOR SHALL LEAVE THE PRESSURE TEST WATER IN THE PIPELINE THE CONTRACTOR SHALL NOT PERFORM SWABBING OR DISINFECTION TESTING ON THE NEW TWMP WATER MAIN. HOWEVER THE CONTRACTOR WILL STILL BE RESPONSIBLE FOR THESE ACTIVITIES PER JEA STANDARDS ON ANY REPLACED SMALL DIAMETER DISTRIBUTION WATER MAINS INCLUDING 16-INCH WATER MAIN FOR INTER-TIE ON CENTURY STREET.

> IOANNIS POLEMATIDIS PE NO. 75392

PROJECT NO. 6103-2297 FILE NAME: GOO1GNSI.DW SHEET NO.

ISSUED FOR BID

REMARKS NOVEMBER 2018 FL COA No. EB-000002

AND SHEET INDEX

JEA GENERAL NOTES

G-1

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- 3. SOIL EXPLORATION WORK WAS PERFORMED BY MESKEL AND ASSOCIATES ENGINEERING, PLLC. OF JACKSONVILLE FL. SOILS EXPLORATION WORK IS SOLELY TO ASSIST BIDDERS IN ASSESSING THE NATURE AND EXTENT OF TESTING PROCEDURES REQUIRED TO MAKE THEIR OWN DETERMINATION OF ACTUAL SUBSURFACE CONDITIONS THAT WILL BE ENCOUNTERED DURING THE COURSE OF THE WORK. NO REPRESENTATION IS MADE OR WILL BE GIVEN BY THE ENGINEER CONCERNING ACTUAL CONDITIONS THAT WILL BE ENCOUNTERED. ALL BIDDERS ARE DIRECTED PRIOR TO BIDDING TO CONDUCT ALL INVESTIGATIONS THEY DEEM NECESSARY TO ARRIVE AT THEIR OWN CONCLUSIONS REGARDING SUCH CONDITIONS.
- 4. CONTRACTOR SHALL INSTALL THE APPROPRIATE SECURITY FENCING AND BARRIERS ON-SITE TO PREVENT PUBLIC ACCESS TO THE SITE AND ENSURE PUBLIC HEALTH AND SAFETY. REFER TO SPECIFICATION SECTION 01010 SUMMARY OF WORK.
- 5. ANY PUBLIC LAND CORNER, PROPERTY MONUMENTATION, OR BENCHMARK WITHIN THE LIMITS OF CONSTRUCTION SHALL BE PROTECTED. IF A CORNER MONUMENT IS IN DANGER OF BEING DESTROYED, THE CONTRACTOR SHALL NOTIFY THE ENGINEER IMMEDIATELY. ANY CORNER MONUMENT DISTURBED OR DESTROYED SHALL BE RESET BY A PROFESSIONAL LAND SURVEYOR REGISTERED IN THE STATE OF FLORIDA, AT NO ADDITIONAL COST TO THE OWNER.
- 6. THE CONTRACTOR SHALL CONTACT THE ENGINEER OR OFFICIAL JEA REPRESENTATIVE IMMEDIATELY REGARDING ANY CONFLICTS THAT ARISE DURING CONSTRUCTION OF WORK SHOWN ON THE DRAWINGS.
- 7. THE CONTRACTOR SHALL ADHERE TO ALL CONDITIONS AND REQUIREMENTS OF ALL PERMITS THAT HAVE BEEN OBTAINED.
- 8. ALL DRIVEWAYS, DRAINAGE PIPES, AND HEADWALLS SHALL BE RESTORED TO EQUAL OR BETTER THAN EXISTING CONDITION, IN BOTH NEW AND EXISTING RIGHTS-OF-WAY AND WITHIN ANY TEMPORARY EASEMENT AREAS. ANY STRUCTURES OR DRIVEWAYS DISTURBED OUTSIDE THE RIGHT-OF-WAY OR EASEMENTS SHALL ALSO BE FULLY RESTORED AT NO COST TO THE OWNER OR PROPERTY OWNER.
- 9. CONTRACTOR SHALL PROTECT ALL DRAIN STRUCTURES, PIPES, AND CULVERTS. MAINTAIN PROTECTION UNTIL DISTURBED AREAS ARE STABILIZED WITH GROUND COVER SUFFICIENT TO PREVENT EROSION.
- 10. CONTRACTOR SHALL INSTALL AT ALL DISTURBED DITCH LINES OR OTHER AREAS OF CONCENTRATED FLOW WHERE FLOW IS GREATER THAN 2 FPS OR GRADIENT IS GREATER THAN 2% A PERMANENT DITCH LINING TO AID IN THE ESTABLISHMENT OF A PERMANENT VEGETATIVE GROUND COVER.
- 11. WHEN EXCAVATED MATERIALS ARE PLACED ON ROADWAY SURFACES, THE CONTRACTOR SHALL PLACE SAND OR STONE SCREENINGS UNDERNEATH THE EXCAVATED MATERIALS AND SHALL REMOVE SAID MATERIALS AND WASH ALL RESIDUALS FROM THE SURFACES DAILY.
- 12. CONTRACTOR SHALL MAINTAIN AN ACCESS CORRIDOR THROUGH THE WORK AREA FOR EMERGENCY VEHICLES AT ALL TIMES.
- 13. THE CONTRACTOR SHALL BE RESPONSIBLE FOR MAINTAINING THE INTEGRITY OF ALL STORM WATER SYSTEMS WHILE EXISTING STORM WATER PIPE SECTIONS ARE UTILIZED FOR FLUID MANAGEMENT. THE CONTRACTOR SHALL PROVIDE A SUBMITTAL WHICH PROVIDES DETAILS ON HOW THIS WILL BE ACCOMPLISHED INCLUDING THE USE OF DETENTION BASINS, BYPASS PUMPING, TEMPORARY PIPING, OR SIMILAR. AT ALL TIMES THE CONVEYANCE CAPACITY OF ALL EXISTING STORMWATER INFRASTRUCTURE SHALL BE MAINTAINED TO PREVENT FLOODING.
- 14. CONTRACTOR SHALL TEMPORARILY RELOCATE AND REPLACE ANY MONUMENTS, SIGNS, FENCES, MAILBOXES, ETC. WITH THE SAME TYPE OF MATERIAL THAT WAS REMOVED DURING CONSTRUCTION.
- 15. WHENEVER WATER SEEPS FROM A SLOPE FACE ADEQUATE DRAINAGE OR OTHER PROTECTION SHALL BE PROVIDED.
- 16. THE CONTRACTOR SHALL INSTALL A STABILIZED CONSTRUCTION ENTRANCE AS DIRECTED BY THE ENGINEER AT LOCATIONS WHERE VEHICULAR TRAFFIC PASSES FROM DISTURBED AREAS ONTO ROADWAYS AS REQUIRED TO PREVENT THE MIGRATION OF SOIL FROM THE PROJECT AREA.
- 17. CARE SHALL BE EXERCISED AT ALL TIMES TO ENSURE THAT TURBID RUNOFF DOES NOT STAGE UP AND CREST OVER THE SERVICE ROAD CROWN INTO THE LANE MAINTAINED FOR TRAFFIC. CONTRACTOR SHALL INSTALL EROSION AND SEDIMENT CONTROLS AT THE DIRECTION OF THE ENGINEER TO PREVENT SUCH OCCURRENCES. THE COST OF INSTALLATION, MAINTENANCE, AND REMOVAL SHALL BE CONSIDERED PART OF THE CONTRACT.
- 18. TOPOGRAPHIC SURVEY WAS PERFORMED BY:
 - R.E. HOLLAND AND ASSOCIATES, INC 4770 BAYMEADOWS ROAD, SUITE 105 JACKSONVILLE, FL. 32256
- 19. CONTRACTOR SHALL COORDINATE WITH UTILITY OWNERS WHEN HOLDING AND PROTECTING OF EXISTING UTILITIES IS REQUIRED WHETHER NOTED ON DRAWINGS OR NOT.
- 20. CONTRACTOR SHALL UTILIZE THE NECESSARY MEASURES FOR NOISE ABATEMENT AS REQUIRED BY THE OWNER DURING DRILLING AND CONSTRUCTION OF THE NEW WELL. THE SPECIFIC REQUIREMENTS SHALL BE DISCUSSED DURING THE PROJECT PRE-BID AND PRE-CONSTRUCTION MEETING.

DETAIL AND SECTION IDENTIFICATION

ABBREVIATIONS AND LEGEND:

FFE - FINISHED FLOOR ELEVATION

HDPE - HIGH DENSITY POLYETHYLENE PIPE

FOC - FIBER OPTIC CABLE

GALV. GLV — GALVANIZED

FL - FLOW LINE

FLG - FLANGED

FM - FORCEMAIN

GA - GUY ANCHOR

GV — GATE VALVE

H.C. HIGH CURB

H.W. HEAD WALL

INV - INVERT

IR - IRON

IP - IRON PIPE

ID - IDENTIFICATION

INT. - INTERSECTION

IPF - IRON PIPE FOUND

G - GAS

IRF - IRON ROD FOUND AC - ASBESTOS CEMENT IRS - IRON ROD SET A.G. – ALLEY GRATE J.W.W. JACKSONVILLE WATER WORKS ARV - AIR RELEASE VALVE L – ARC LENGTH BC - BOTTOM OF CURVE LT – LEFT ₽ - BASE LINE MARV - MANUEL AIR RELEASE VALVE B.M. - BENCH MARK MB - MAIL BOX BOC - BACK OF CURB MES - MITERED END SECTION C - CUT MH - MANHOLE CB - CHORD BEARING MISC - MISCELLANEOUS C.B. – CATCH BASIN MJ - MECHANICAL JOINT C.E.P. - CITY ELECTRIC POLE MH - MANHOLE C.I. - CAST IRON NAVD — NORTH AMERICAN VERTICAL DATUM C&G - CURB & GUTTER N.T.S. - NOT TO SCALE \mathbb{Q} - CENTER LINE O.E. - OVERHEAD ELECTRIC CLA - CENTERLINE OF ASPHALT OR - OFFICIAL RECORDS CLDI - CONCRETE LINED DUCTILE IRON O.T. - OVERHEAD TELEPHONE CLF - CHAIN LINK FENCE TEL - TELEPHONE CH - CHORD DISTANCE PI - POINT OF INTERSECTION CMF - CONCRETE MONUMENT FOUND PC - POINT OF CURVATURE C.M.P — CORRUGATED METAL PIPE PCC - POINT OF COMPOUND CURVE C.M.P.A. - CORRUGATED METAL PIPE ARCH PC 150 - PRESSURE CLASS 150 CPP - CONCRETE POWER POLE PG - PAGE CPP - CORRUGATED PLASTIC PIPE PVC - POLY VINYL CHLORIDE CONC. - CONCRETE PRC - POINT OF REVERSE CURVATURE CONST. - CONSTRUCTION P.R.M. - PERMANENT REFERENCE MONUMENT CTV - CABLE TV PT - POINT OF TANGENCY CULV. - CULVERT P.V.C. - POLYVINYL CHLORIDE D.B.I. - DITCH BOTTOM INVERT R - RADIUS DB - DIRECT BURY R – RATE DI - DUCTILE IRON R.C.P. - REINFORCED CONCRETE PIPE Δ – DELTA ANGLE R.D. - ROOF DRAIN D.W OR DR - DRIVEWAY RE# — REAL ESTATE NUMBER EA - EDGE OF ASPHALT REF - REFERENCE ECC - ECCENTRIC RDCR-REDUCER RJ- RESTRAINED JOINT ELEC - ELECTRIC RT - RIGHT ELEV - ELEVATION R/W - RIGHT OF WAY E.O.P. - EDGE OF PAVEMENT RW - RAW WATER ERCP - ELLIPTICAL REINFORCED CONC. PIPE S.B.T. - SOUTHERN BELL TELEPHONE EXP. JT. - EXPANSION JOINT SB - SOIL BORING F – FILL SD - SOFT DIG FH - FIRE HYDRANT


S/W - SIDEWALK STA - STATION TC - TOP OF CURVE TOB - TOP OF BANK TOS - TOE OF SLOPE VERT. – VERTICAL UG - UNDERGROUND UGE - UNDERGROUND ELECTRIC UGT - UNDERGROUND TELEPHONE

V.C. - VITRIFIED CLAY HFAC - HARNESS FLANGE ADAPTOR COUPLING VPI - VERTICAL POINT INFLECTION W - WATER WLP - WOOD LIGHT POLE WM - WATER METER WPP - WOOD POWER POLE WTP - WOOD TELEPHONE POLE

UNK - UNKNOWN

WV - WATER VALVE


DETAIL DESIGNATION_ **DETAIL** 1/4" = 1'-0" SHEET ON WHICH DETAIL IS LOCATED

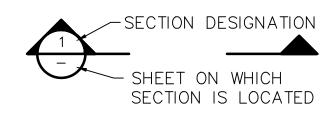

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DETAIL REFERENCE

SECTION REFERENCE

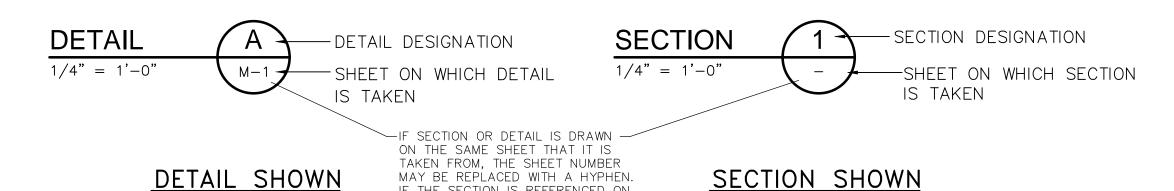


IF THE SECTION IS REFERENCED ON

SHOWN SHOULD INDICATE THE FIRST

SHEET THE SECTION IS TAKEN FROM.

MULTIPLE SHEETS, THE SHEET NUMBER

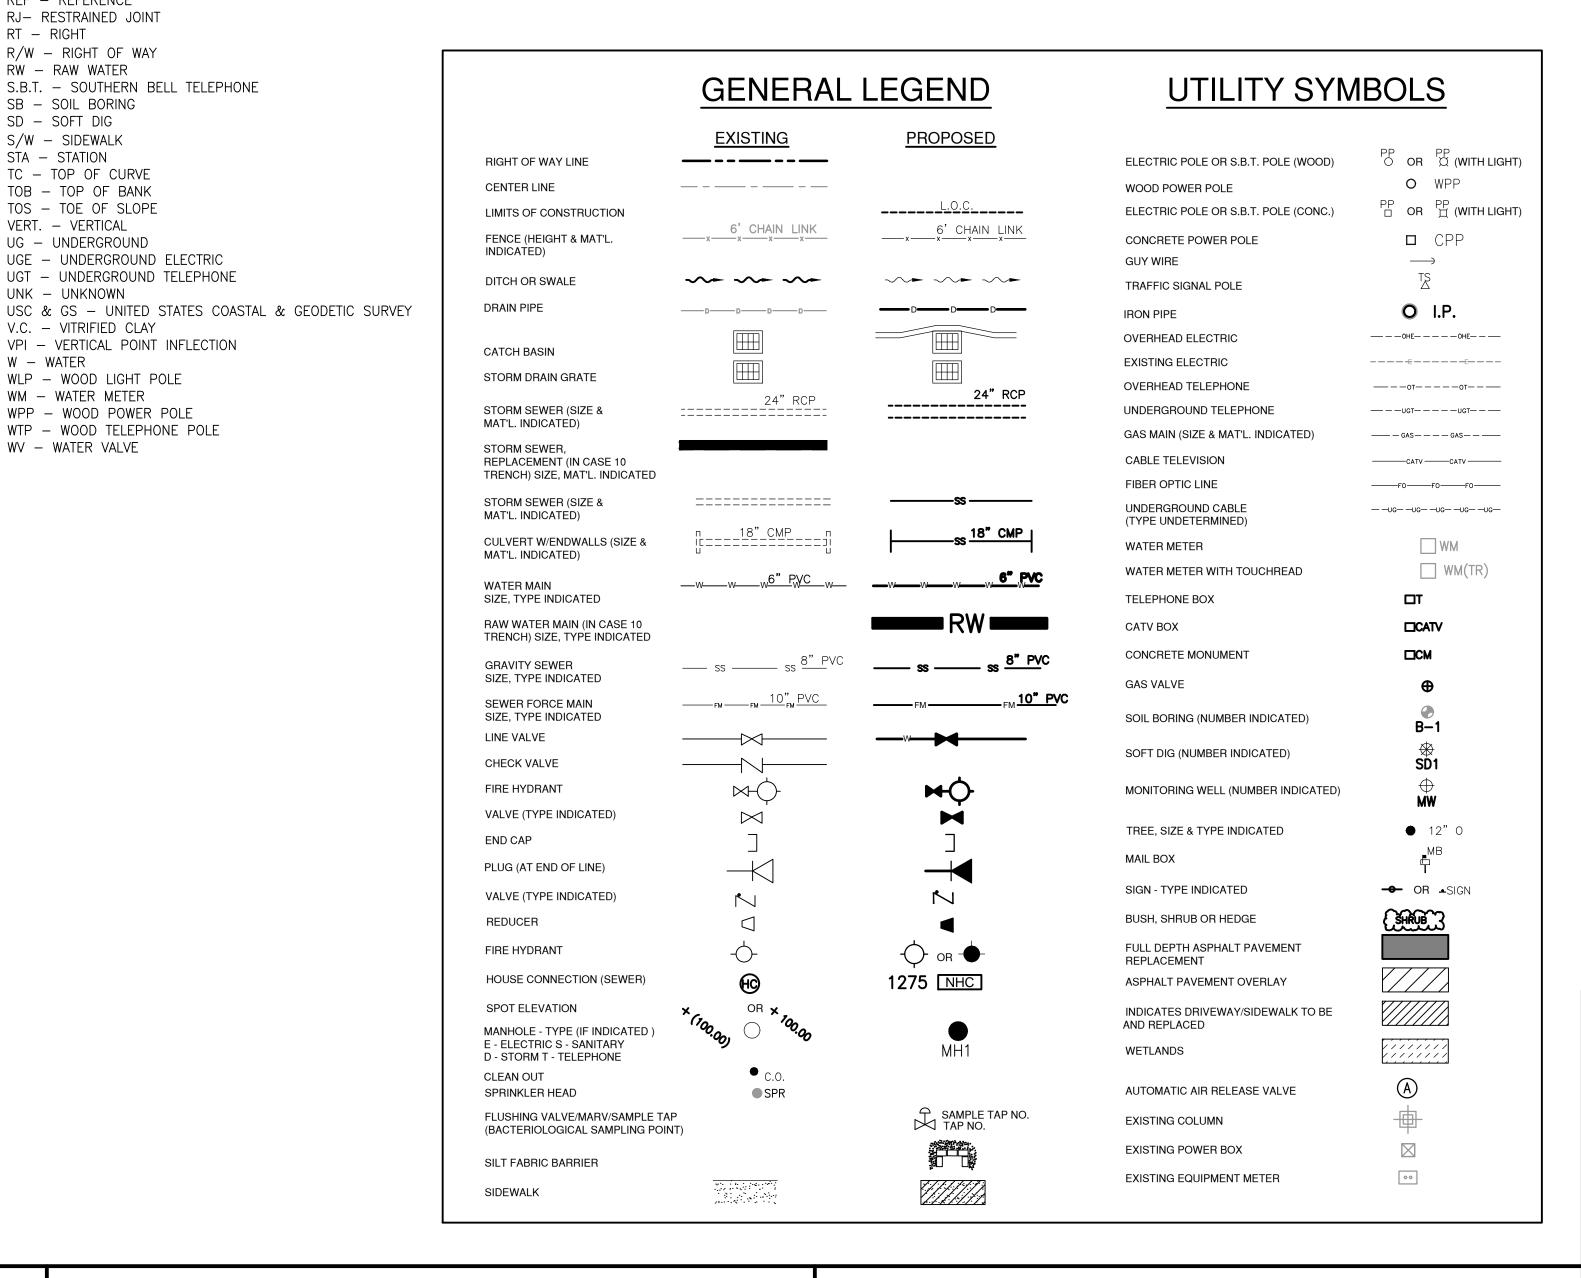

B. SCHNEIDER A. NUNES J. HEALY L. WISEMAN I. POLEMATIDIS DRWN CHKD REMARKS NOVEMBER 201

8381 Dix Ellis Trail, Suite 400 Jacksonville, FL 32256 Tel: (904) 731-7109 FL COA No. EB-000002

GREENLAND WATER TREATMENT PLANT - BACKUP WELL (WELL NO. 3) WELL DRILLING


GENERAL NOTES AND LEGEND


IOANNIS POLEMATIDIS PE NO. 75392 PROJECT NO. 6103-2297


> SHEET NO. G-2


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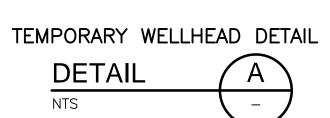




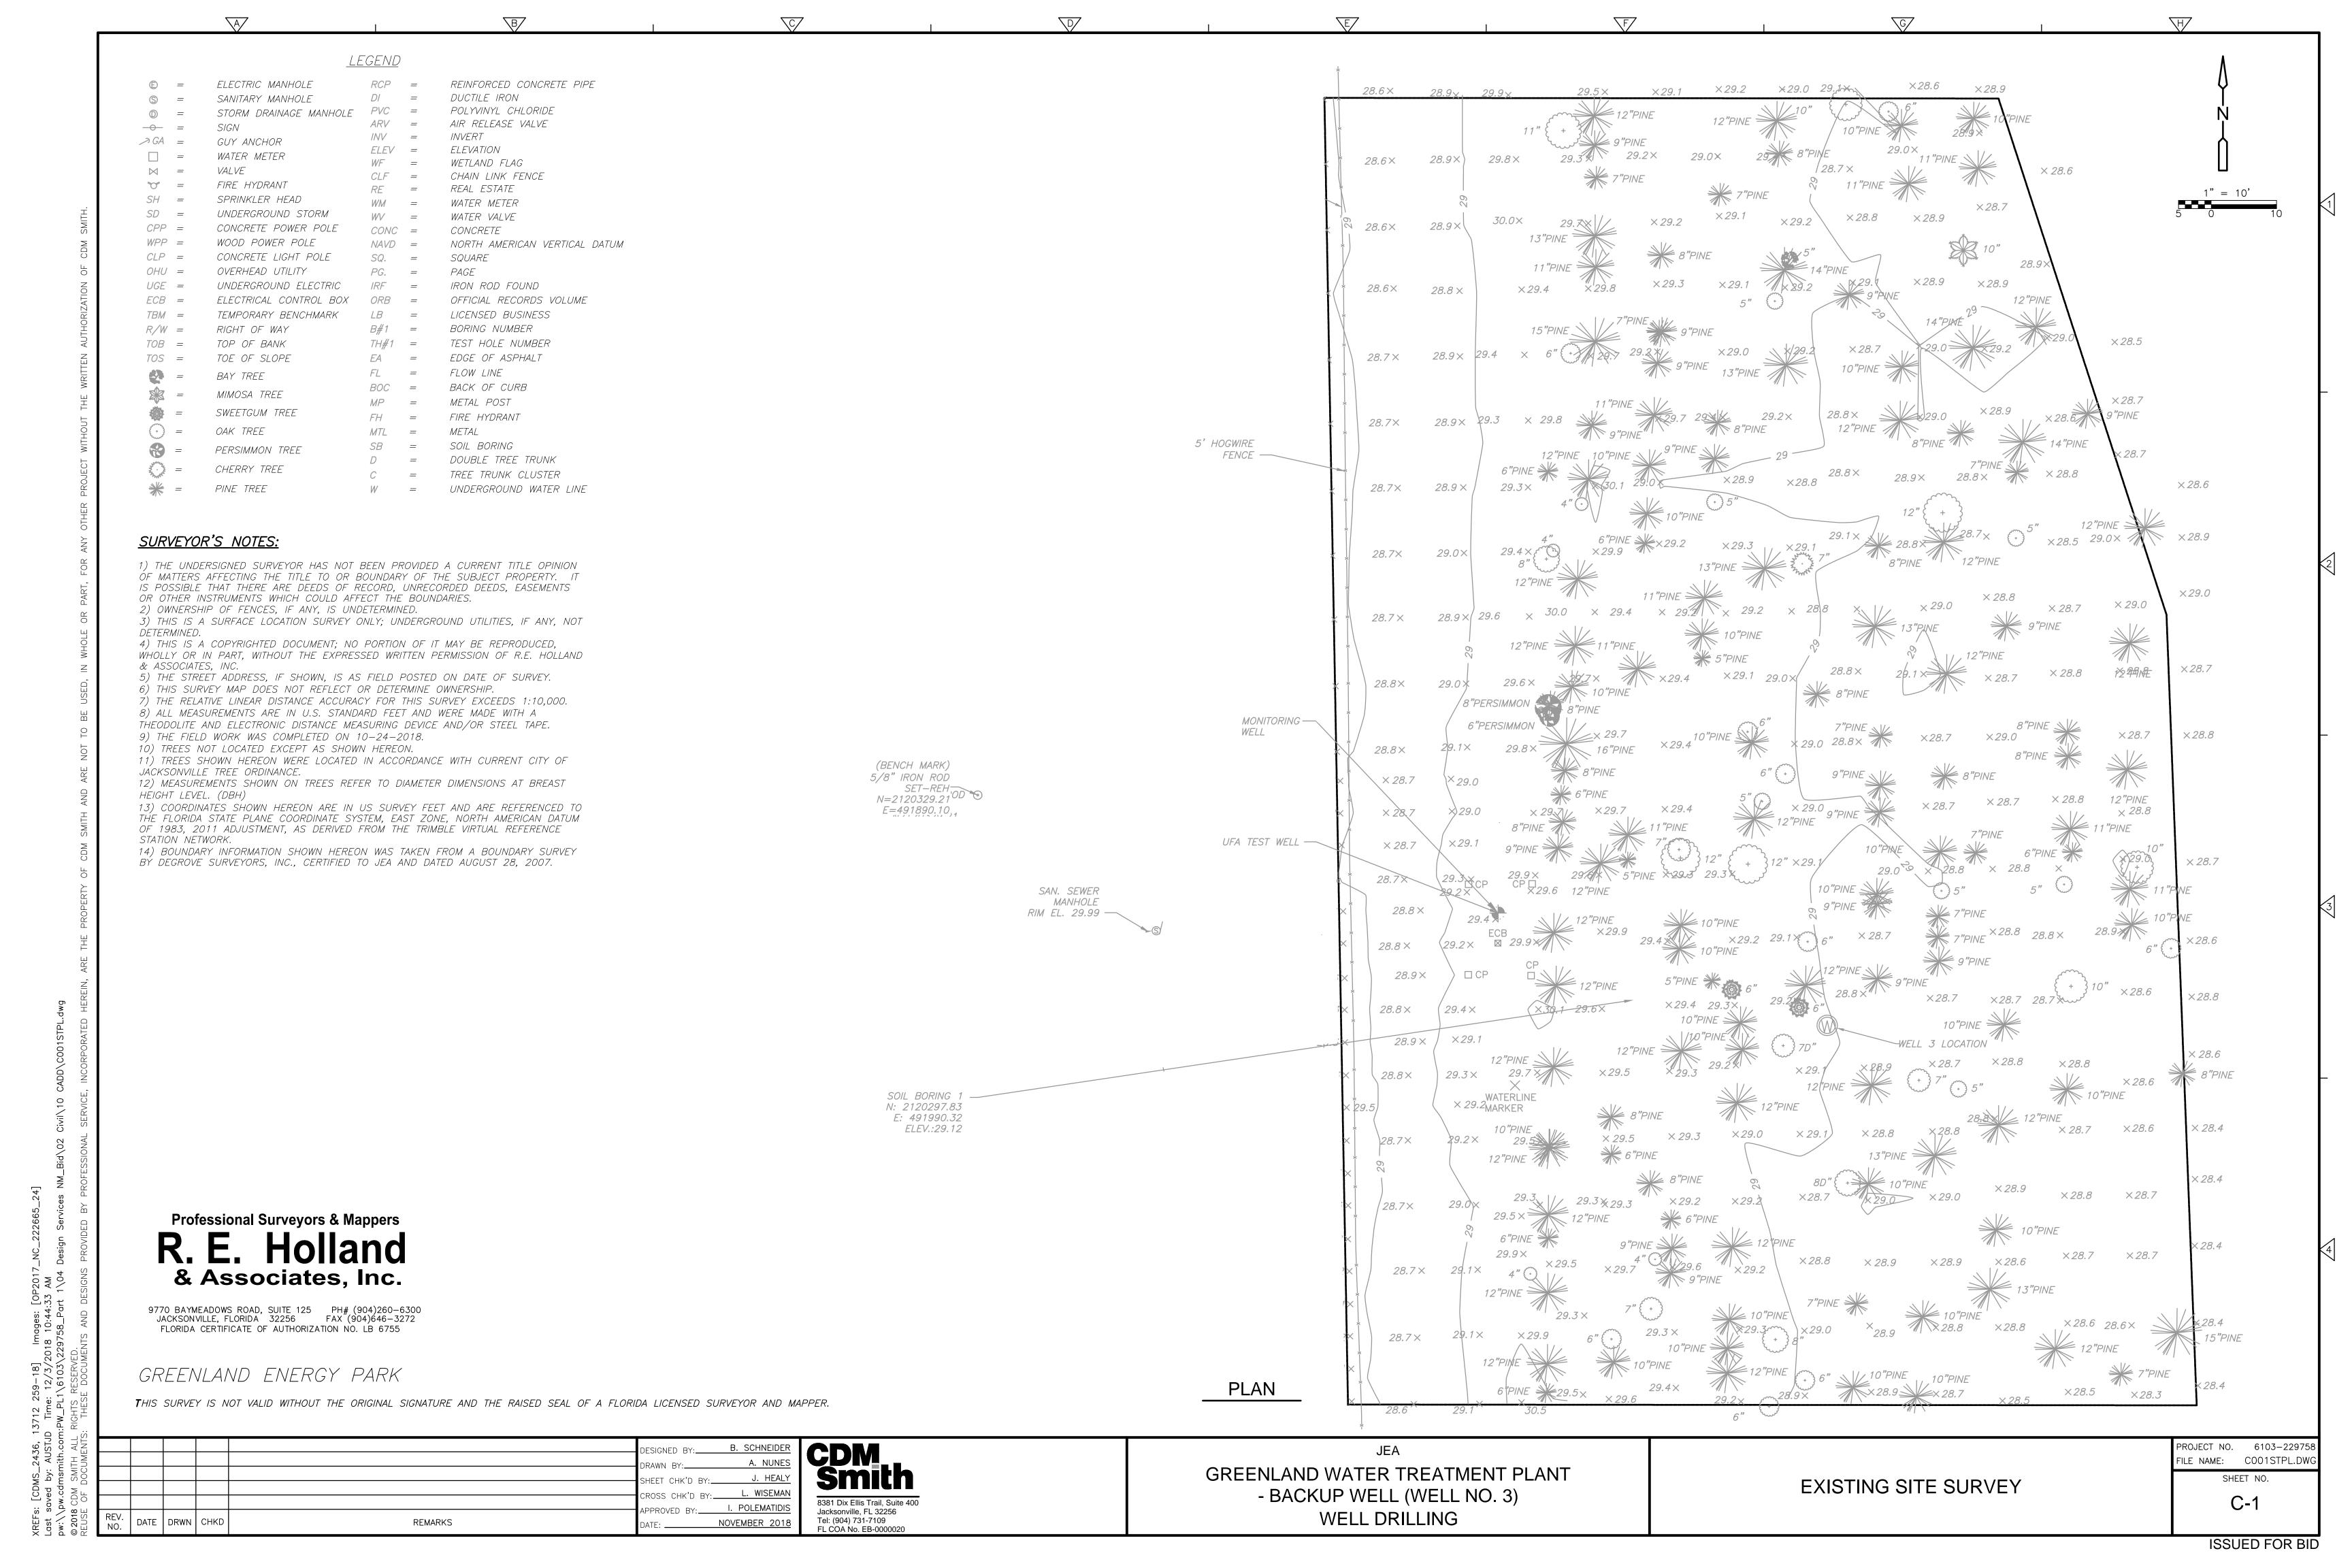

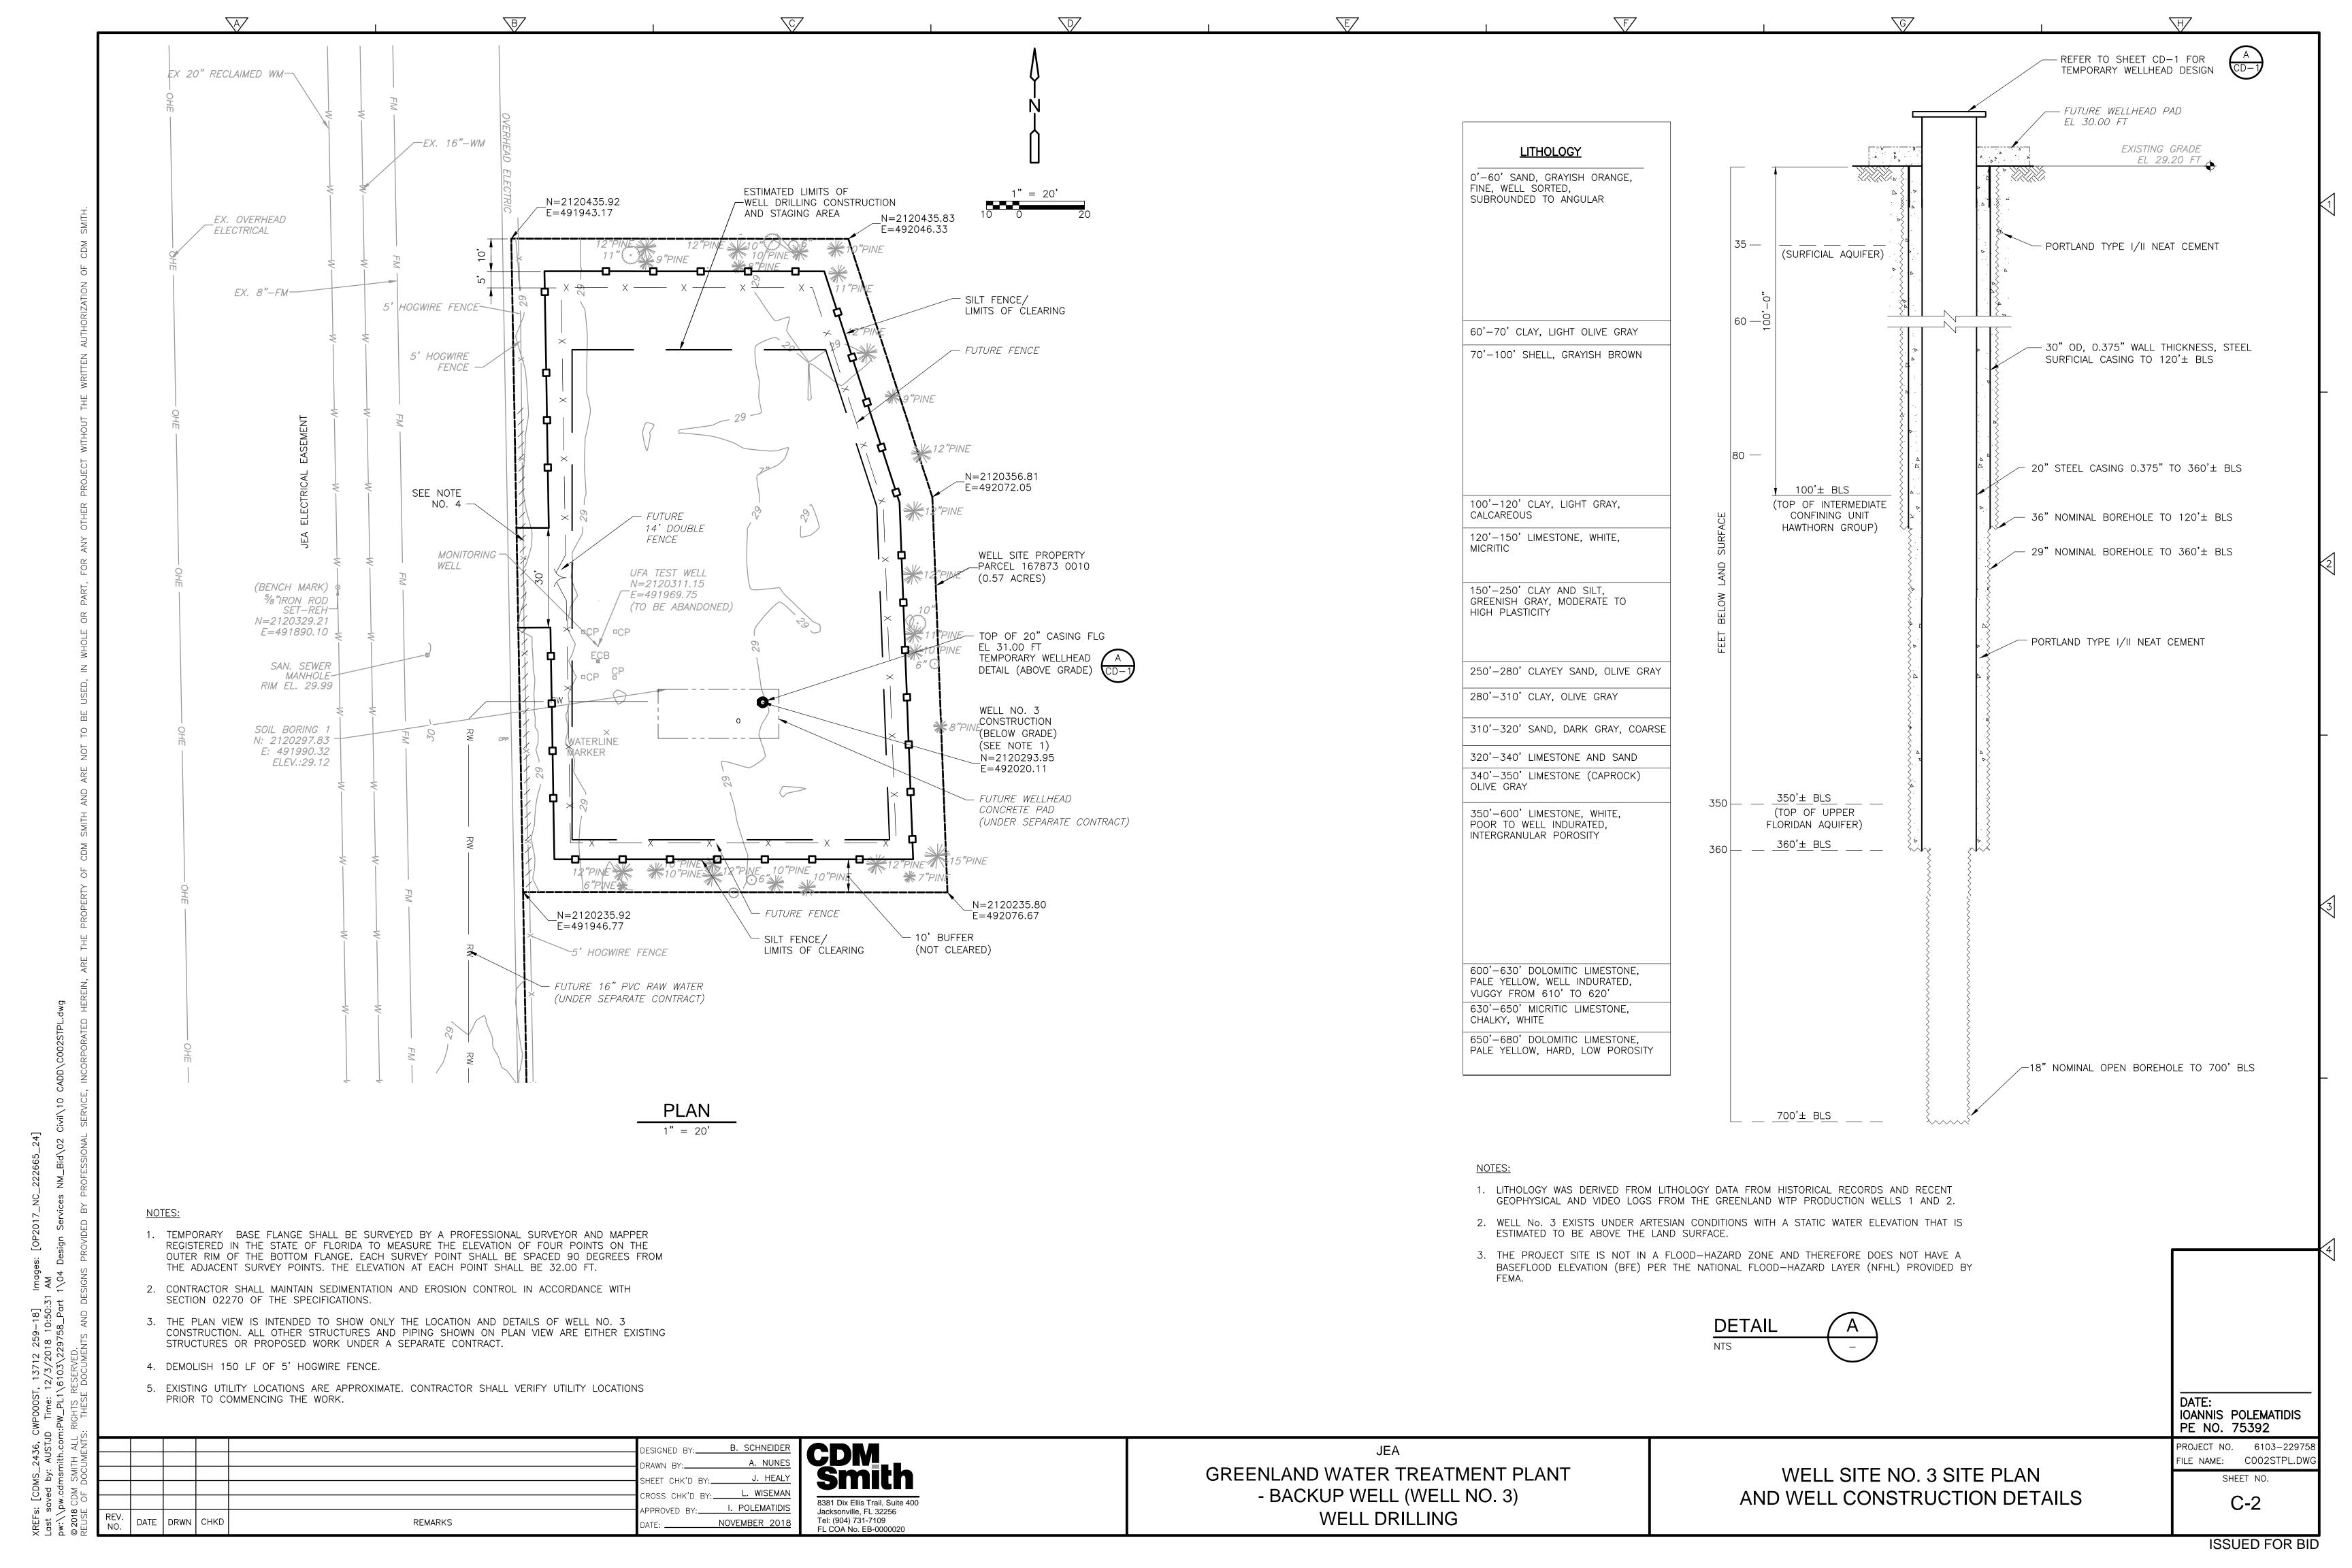NOTES:

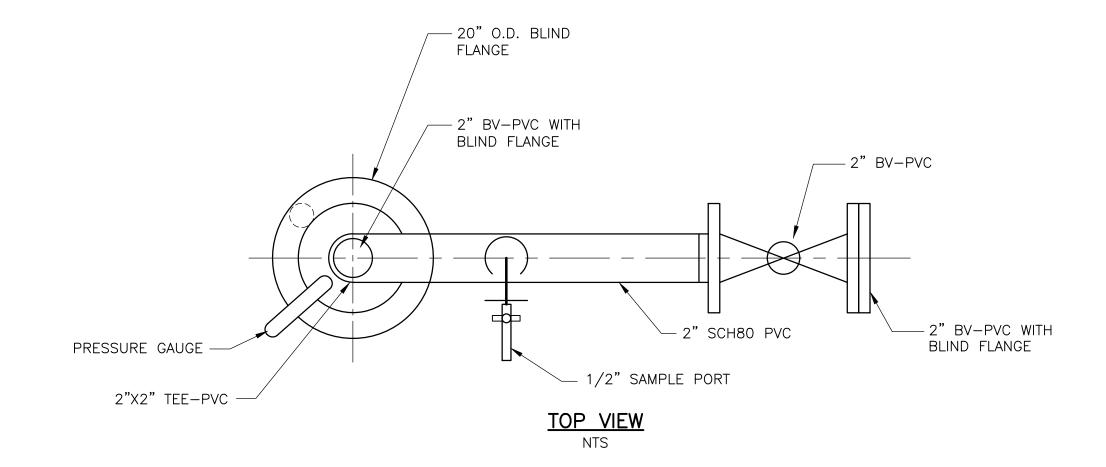- 1. CONTRACTOR SHALL TERMINATE THE 20" STEEL CASING TO A FLANGE ELEVATION OF 32.00 FT. EXISTING GROUND ELEVATION SHALL BE FINISHED TO ELEVATION 29.20 FEET BY OTHERS.
- 2. CONTRACTOR SHALL TURN OVER ALL TEMPORARY APPURTENANCES (PRESSURE GAUGES, SAMPLE PORTS, VALVES AND FITTINGS) FROM THE TEMPORARY WELLHEAD TO OWNER (JEA) AT THE COMPLETION OF THE PROJECT.
- 3. SEE DETAIL A SHEET C-2 FOR MATERIAL OF CONSTRUCTION. WALL THICKNESS AND DEPTH OF SURFACE CASING AND FINAL CASING.
- 4. CONTRACTOR SHALL ENSURE THAT THE TEMPORARY BASE FLANGE ELEVATION IS SET AT 32.00 FT. AND IS MEASURED IN AT LEAST FOUR LOCATIONS BY A CERTIFIED SURVEYOR. THE FINAL FLANGE SHALL BE CONSTRUCTED TO A LOWER ELEVATION BY OTHERS.

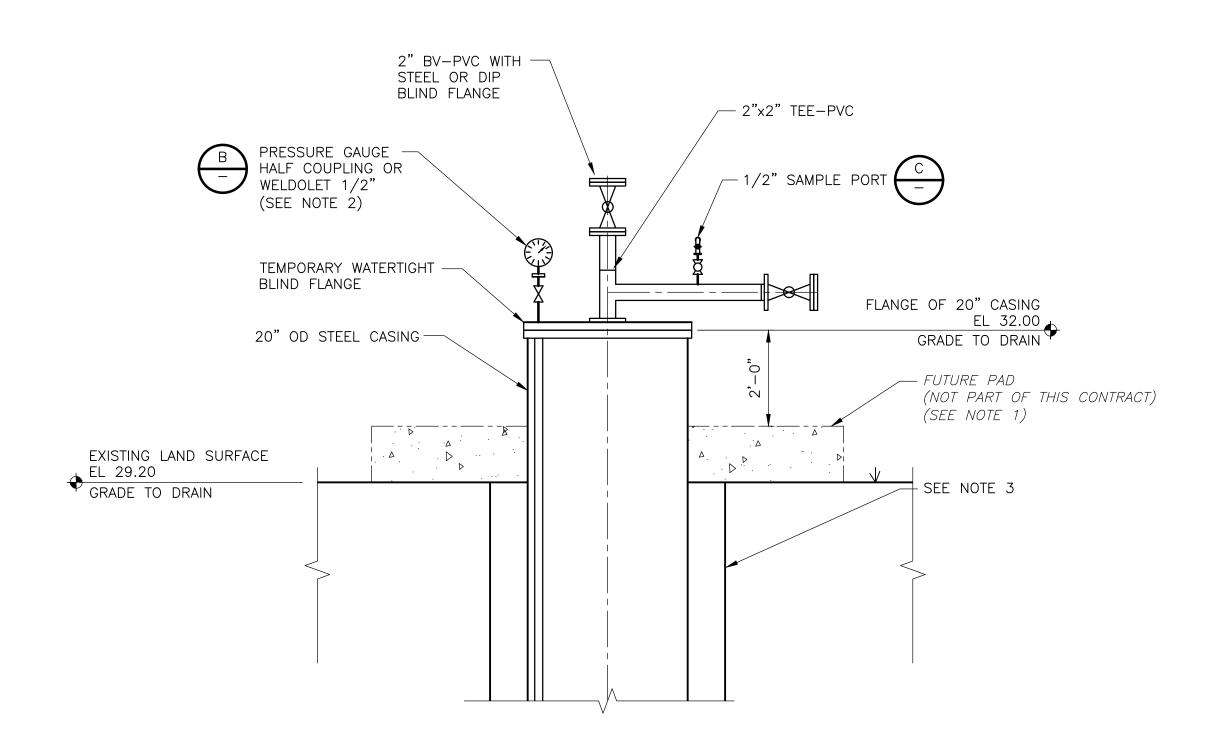

| NOVEMBER 2018

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8381 Dix Ellis Trail, Suite 400
Jacksonville, FL 32256
Tel: (904) 731-7109
FL COA No. EB-0000020

GREENLAND WATER TREATMENT PLANT
- BACKUP WELL (WELL NO. 3)
WELL DRILLING

WELL NO. 3 TEMPORARY WELLHEAD DETAILS

1/2"x90° BEND SCH80 PVC WITH VERTICAL NPT NIPPLE (TYP)

1/2" PVC BALL VALVE

1/2" HALF COUPLING, THREADED TO PIPE OR TAPPED CONNECTION

H

NOTE:

1/4" BALL VALVE —

1. PIPE SHALL BE SCHEDULE 80 PVC WITH NTP (NATIONAL PIPE THREAD) FITTINGS AND FLANGES. 150 POUND CLASS BY SWAGEWLOK, OR EQUAL. FLANGE GASKETS SHALL BE 1/16—INCH MINIMUM NEOPRENE. FLANGE BOLTS SHALL BE HEX—HEAD ASTM A193 GRADE B&M, AND NUTS SHALL BE HEX—HEAD ASTM A194 GRADE 8M. PIPE THREAD SEALANTS SHALL BE USED IN ACCORDANCE WITH THE FITTINGS MANUFACTURER, BUT SHALL NOT CONTAIN HAZARDOUS SUBSTANCES OR DELETERIOUS COMPOUNDS THAT WOULD CAUSE A VIOLATION OF WATER QUALITY HEALTH—EFFECTS STANDARDS IF SUBSEQUENTLY INTRODUCED DURING OPERATIONS. FIELD WELDING SHALL ONLY BE DONE WITH THE ENGINEER'S APPROVAL BY APPROPRIATELY CERTIFIED WELDERS.

- PRESSURE GAUGE

└─ 1/4" BALL VALVE

PRESSURE GAUGE

DETAIL

B

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1. GAUGE SHALL BE ASHCROFT PLUS MODEL AC 35-1009SW-02L-60#

OR APPROVED EQUAL.

SAMPLE PORT

DETAIL

O

NTS

C

DATE:
IOANNIS POLEMATIDIS
PE NO. 75392

PROJECT NO. 6103-22975

FILE NAME: CD01STDT.DW

SHEET NO.

CD-1

ISSUED FOR BID

mith.com:PW_PL1\6103\229758_Part 1\04 Design Services NM_Bid\02 Civil\10 CADD\CD01STDT.dwg
AITH ALL RIGHTS RESERVED.

<u>LEGEND</u>

(E)	=	ELECTRIC MANHOLE	RCP	=	REINFORCED CONCRETE PIPE
S	=	SANITARY MANHOLE	DI	=	DUCTILE IRON
(D)	=	STORM DRAINAGE MANHOLE	PVC	=	POLYVINYL CHLORIDE
	=	SIGN	ARV	=	AIR RELEASE VALVE
→ GA	_	GUY ANCHOR	INV	=	INVERT
	_	WATER METER	ELEV	=	ELEVATION
\bowtie	=	VALVE	WF	=	WETLAND FLAG
0	=	FIRE HYDRANT	CLF	=	CHAIN LINK FENCE REAL ESTATE
SH	_	SPRINKLER HEAD	RE	=	
SD	_	UNDERGROUND STORM	WM WV	=	WATER NALVE
CPP	_	CONCRETE POWER POLE	CONC	=	WATER VALVE CONCRETE
WPP	=	WOOD POWER POLE	NAVD	= =	NORTH AMERICAN VERTICAL DAT
CLP	_	CONCRETE LIGHT POLE	SQ.	<u>-</u>	SQUARE
OHU	_ =	OVERHEAD UTILITY	PG.	_	PAGE
UGE	_	UNDERGROUND ELECTRIC	rg. IRF	_	IRON ROD FOUND
ECB	_	ELECTRICAL CONTROL BOX	ORB	_	OFFICIAL RECORDS VOLUME
TBM			LB	=	
	=	TEMPORARY BENCHMARK		=	LICENSED BUSINESS
R/W	=	RIGHT OF WAY	B#1	=	BORING NUMBER
TOB	=	TOP OF BANK	TH#1	=	TEST HOLE NUMBER
TOS	=	TOE OF SLOPE	EA	=	EDGE OF ASPHALT
63	=	BAY TREE	FL	=	FLOW LINE
	=	MIMOSA TREE	BOC	=	BACK OF CURB
2003 -Ma			MP	=	METAL POST
(0)	=	SWEETGUM TREE	FH	=	FIRE HYDRANT
\odot	=	OAK TREE	MTL	=	METAL
	=	PERSIMMON TREE	SB	=	SOIL BORING
June 2			D	=	DOUBLE TREE TRUNK
Z Z	=	CHERRY TREE	С	=	TREE TRUNK CLUSTER
	=	PINE TREE	W	=	UNDERGROUND WATER LINE
41,					

٨	MITIGATION REQUIREMENTS									
TREE INCHES REMOVED	TOTAL CREDITS			REQUIRED REPLACEMENT	CONTRIBUTION TO COJ TRUST FUND					
11.5-23.5 (3:1)	36	37	0	0	0" @ \$148/INCH					
> 23.5 (1:1)	0	0	O	0						
LIVE OAKS (1:1)	0	0	0	0						
TOTAL				0	\$0.00					


LEGEND

12"PINE

NON-PROTECTED TREE TO BE REMOVED

12"OAK PROTECTED TREE TO BE PRESERVED W/ BARRICADE

8"OAK TREE CREDIT TO BE PRESERVED W/ BARRICADE

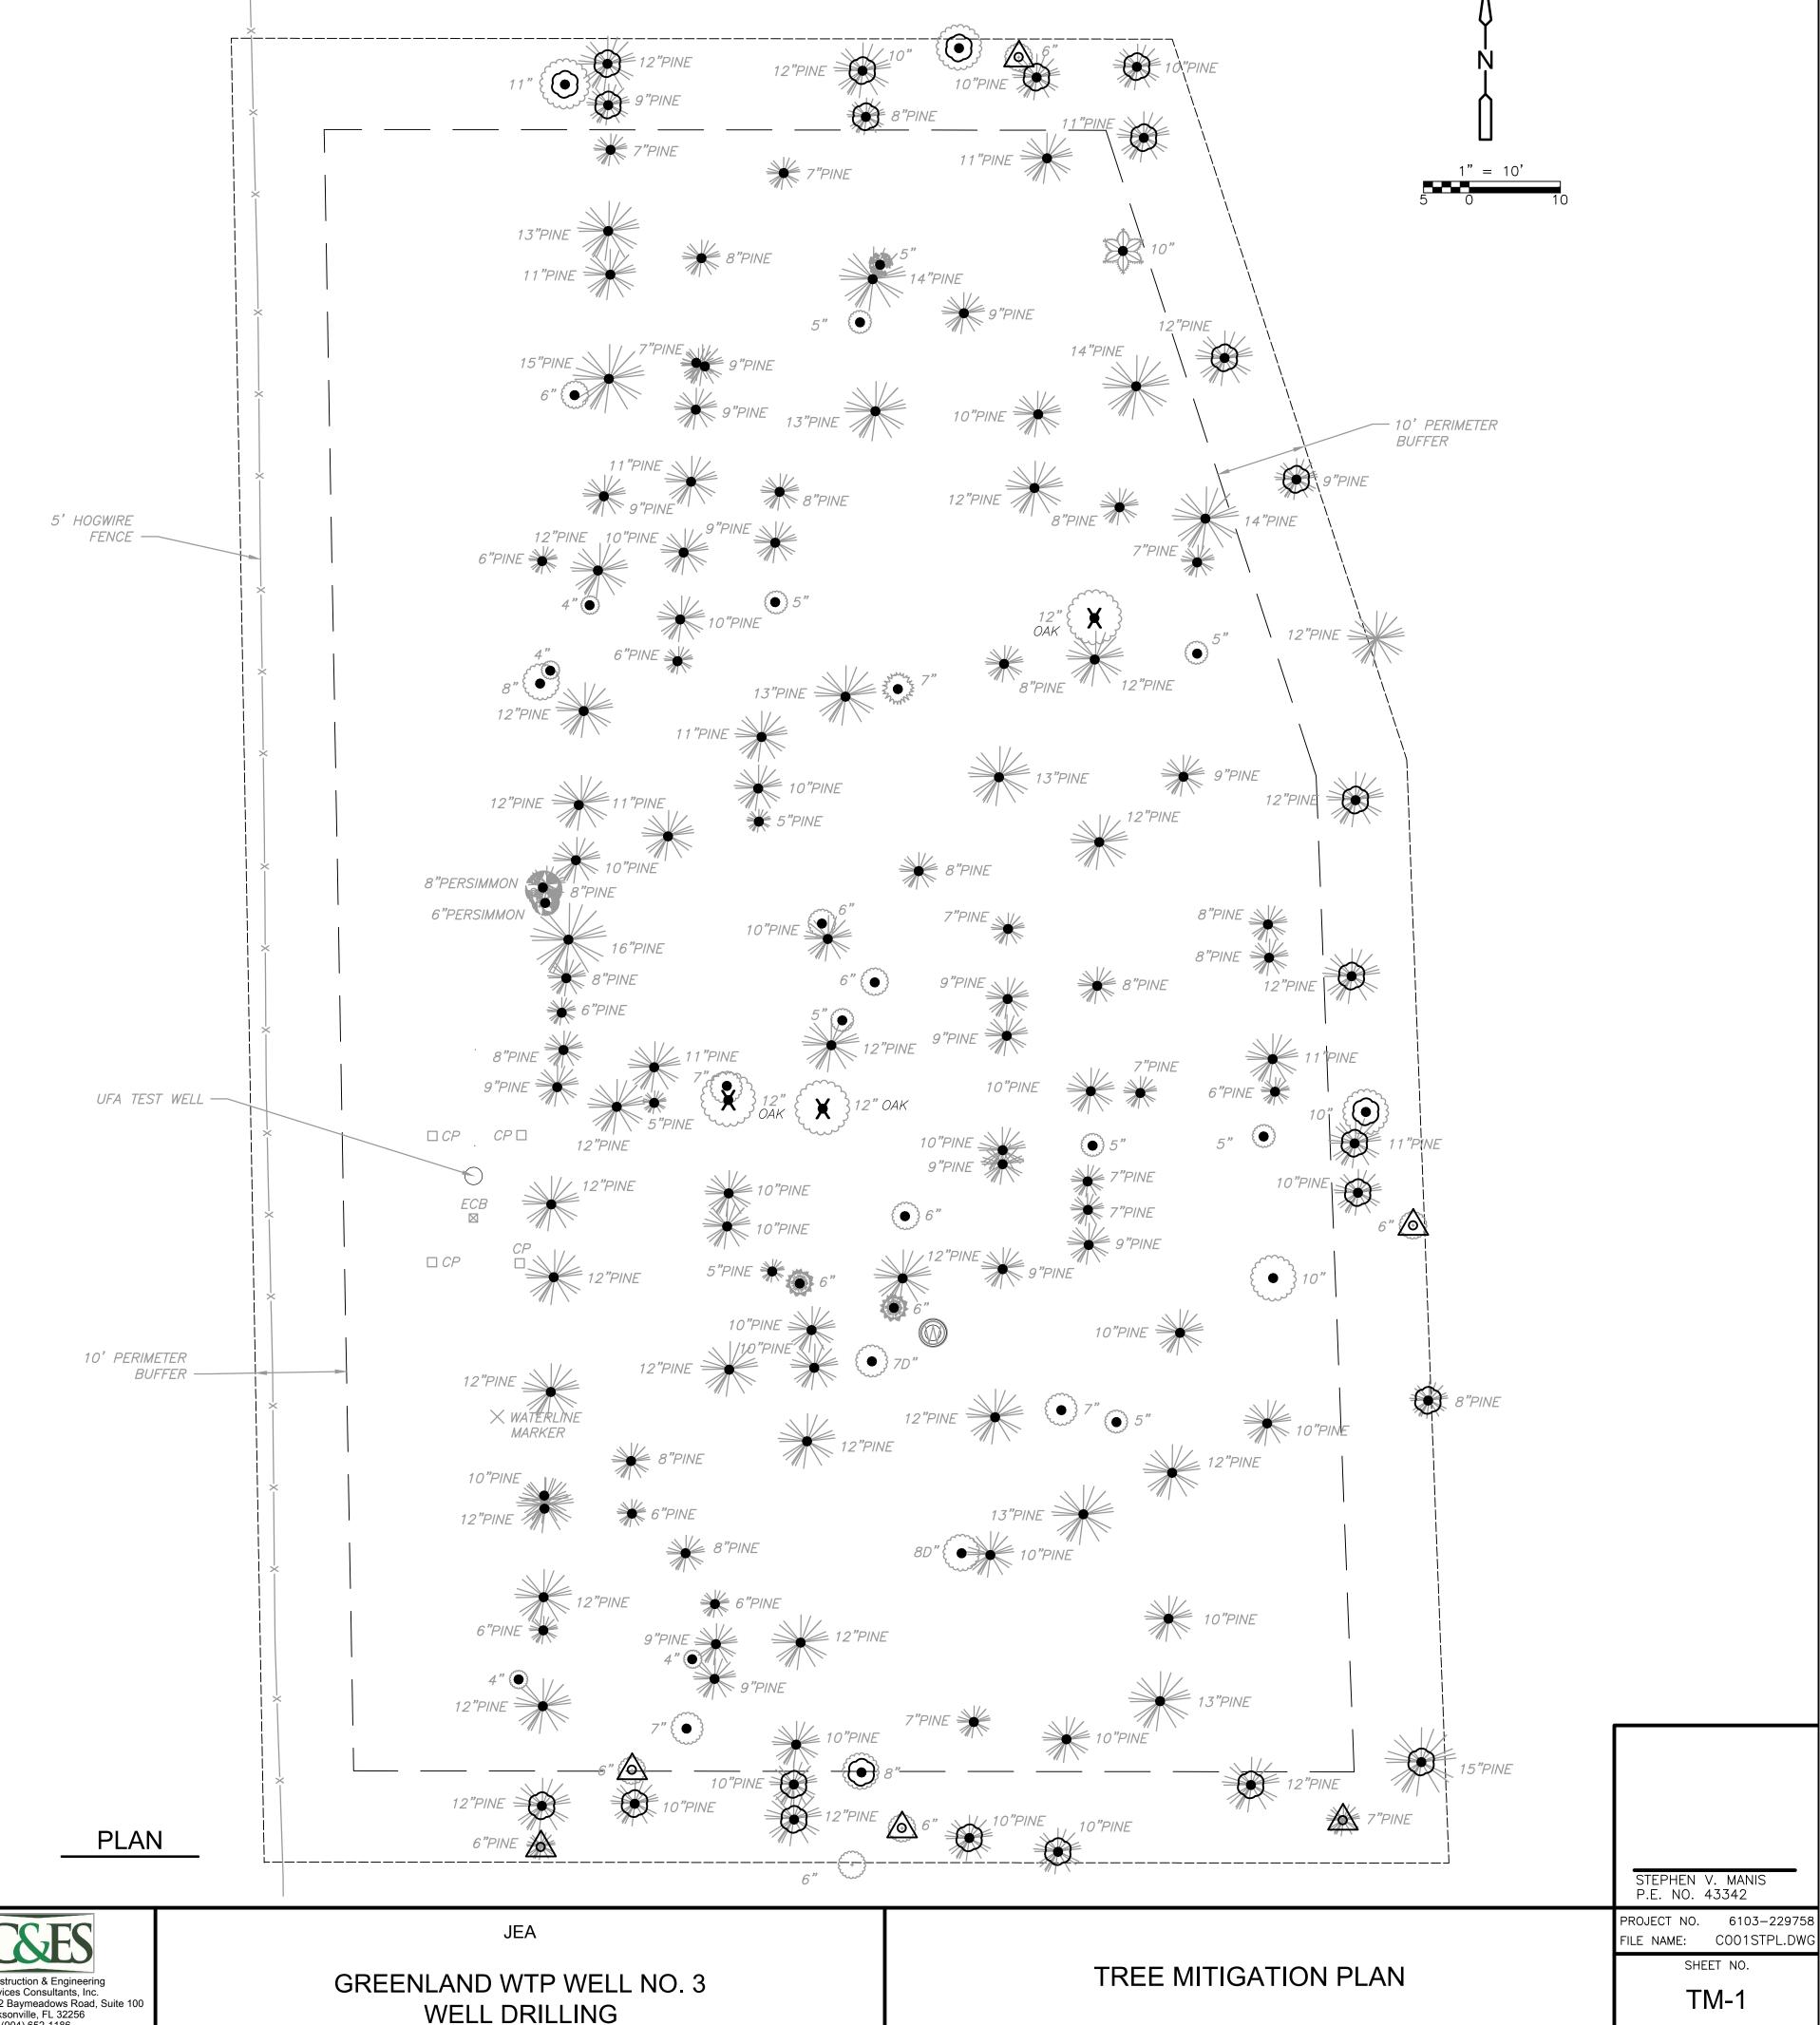

F. GREY S. MANIS REV. DATE DRWN CHKD REMARKS

8381 Dix Ellis Trail, Suite 400 Jacksonville, FL 32256 Tel: (904) 731-7109 FL COA No. EB-0000020

Construction & Engineering Services Consultants, Inc. 9432 Baymeadows Road, Suite 100 Jacksonville, FL 32256 Tel: (904) 652-1186 Business Number CA 27598

WELL DRILLING